SITE PLAN REVIEW SUBMITTAL

O'BRIEN & SONS CORPORATE OFFICE

17 TROTTER DRIVE (MAP 54, PARCEL 1) MEDWAY, MASSACHUSETTS 02053

OWNER

ANTHONY & MARGURITE MELE 203 MAIN STREET MEDWAY, MASSACHUSETTS 02053

APPLICANT

BOTTLE CAP LOT, LLC 93 WEST STREET MEDFIELD, MASSACHUSETTS 02052

CIVIL ENGINEERING, SURVEYING & LANDSCAPE ARCHITECTURE



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ARCHITECTURE

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ZONING DISTRICT: INDUSTRIAL III GROUNDWATER PROTECTION DISTRICT/ZONE II

MAY 23, 2017 REVISED SEPTEMBER 1, 2017



NORTH



DRAWING INDEX:


- C-0 COVER SHEET/LOCUS MAP
- C-1 EXISTING CONDITIONS PLAN
- C-2 LAYOUT AND MATERIALS PLAN
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APPROVED WAIVERS:


SITE PLAN RULES AND REGULATIONS:


- SECTION 204-5 C.3. (EXISTING LANDSCAPE INVENTORY) TO NOT SHOW TREES BETWEEN 12" AND 18" (TREES 18" AND LARGER SHOWN).
- SECTION 205-6 G.3.a PARKING STALL DESIGN SHALL BE 10'x20'. SITE COMPLIES WITH THE ZONING BY-LAW (7.1.1.E.3.a.) STATING 9'x18' AS THE REGULATION (9'x18' STANDARD).
- SECTION 205-6 G.3.b (WHEEL STOPS ABUTTING A WALKWAY) NOT PROVIDED, 7' WIDE SIDEWALK PROPOSED TO ACCOMMMODATE VEHICLE OVERHANG.
- SECTION 205-6 G.4.a (PARKING PROHIBITED IN BUILDING ENTRANCE "AREA" AND LOADING DOCK "AREA") RELIEF REQUESTED.
- SECTION 205-6 G.4.b (NO PART OF ANY PARKING SHALL BE LOCATED WITHIN 15' OF A SIDE PROPERTY LINE.) 7.1' PROPOSED AT SOUTH PROPERTY LINE. ALDER STREET CUL-DE-SAC ALTERATION PROPOSED.
- SECTION 205-6 G.4.d (THE LAST PARKING STALL IN ANY DEAD END ROW SHALL BE 12' LONG X 20' WIDE TURNING AREA). PROVIDING 6'X24' AREA.
- SECTION 205-6 H. (PARKING AREA TO BE BOUNDED WITH VERTICAL GRANITE CURB)
 PRECAST CONCRETE CURB PROPOSED.


I HEREBY CERTIFY THAT NOTICE OF APPROVAL OF THIS PLAN BY THE MEDWAY PLANNING BOARD WAS RECEIVED AND RECORDED AT THIS OFFICE AND THAT NO NOTICE OF APPEAL WAS FILED IN 20 DAYS FOLLOWING SAID RECEIPT AND RECORDING.

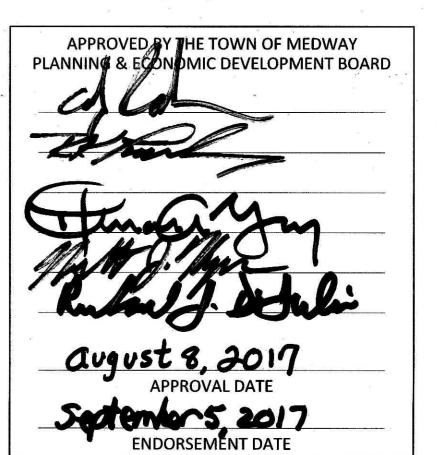

DWG Location GIN~\8477 MEDWAY\DWG\8

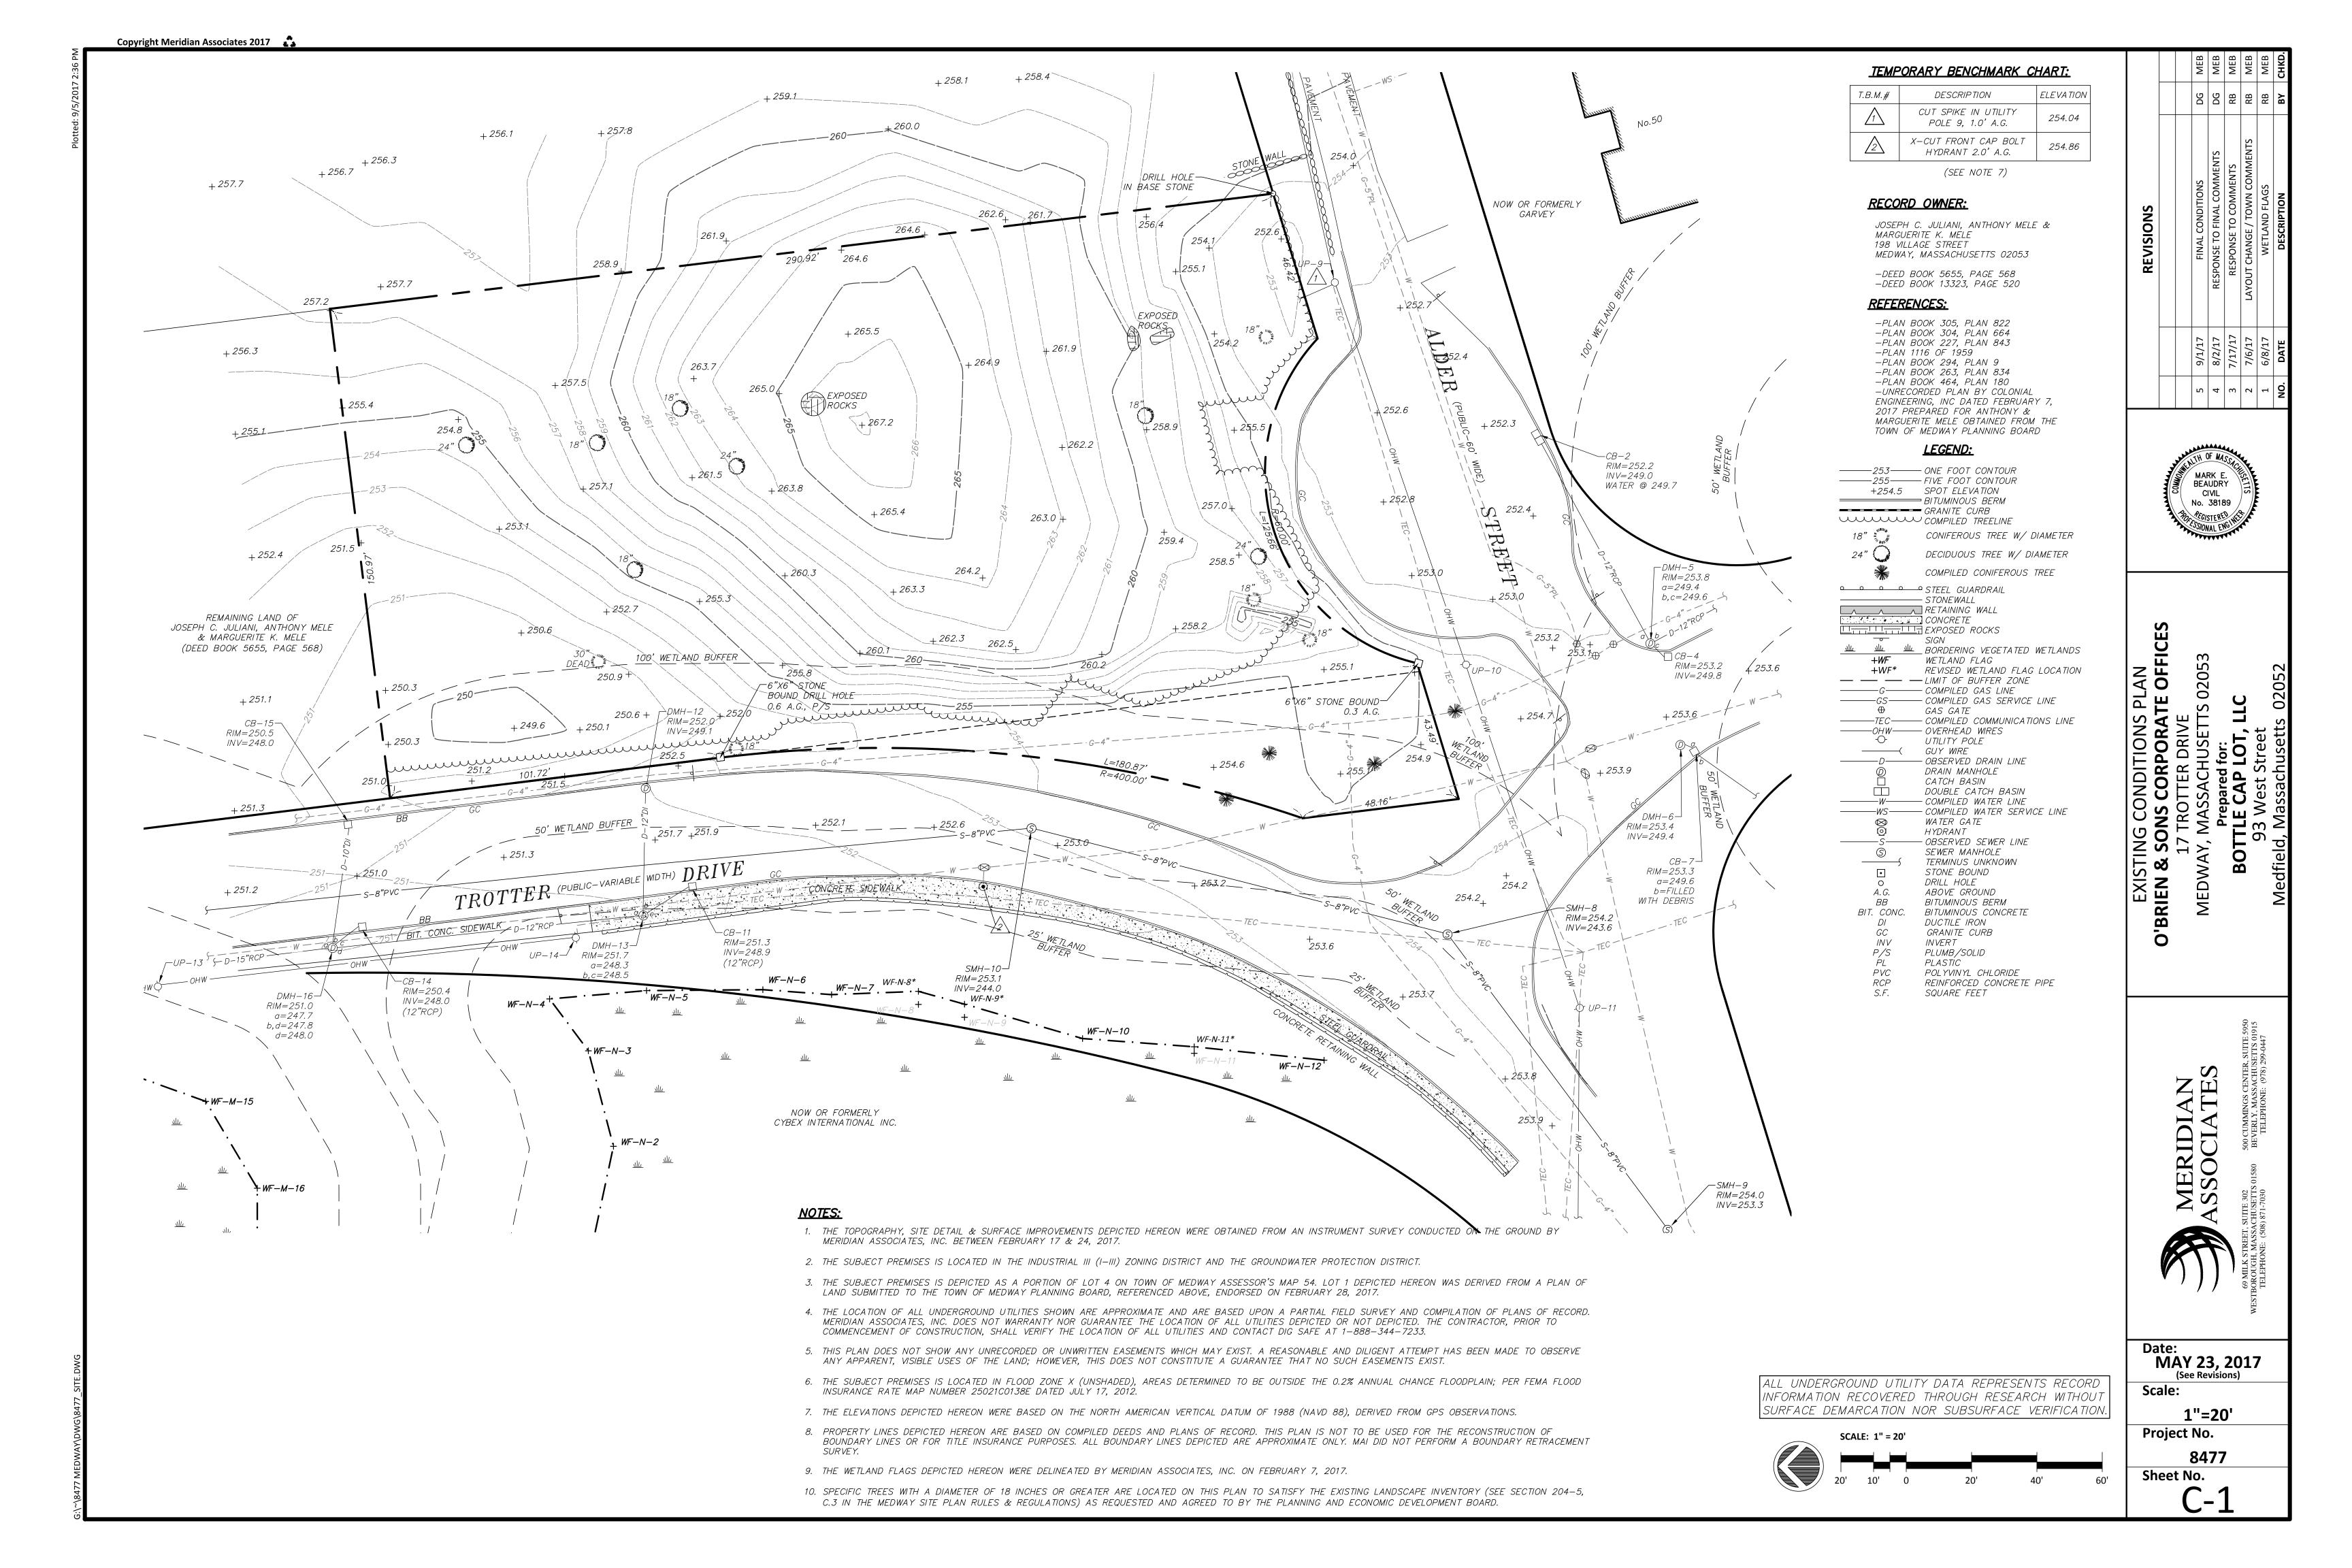

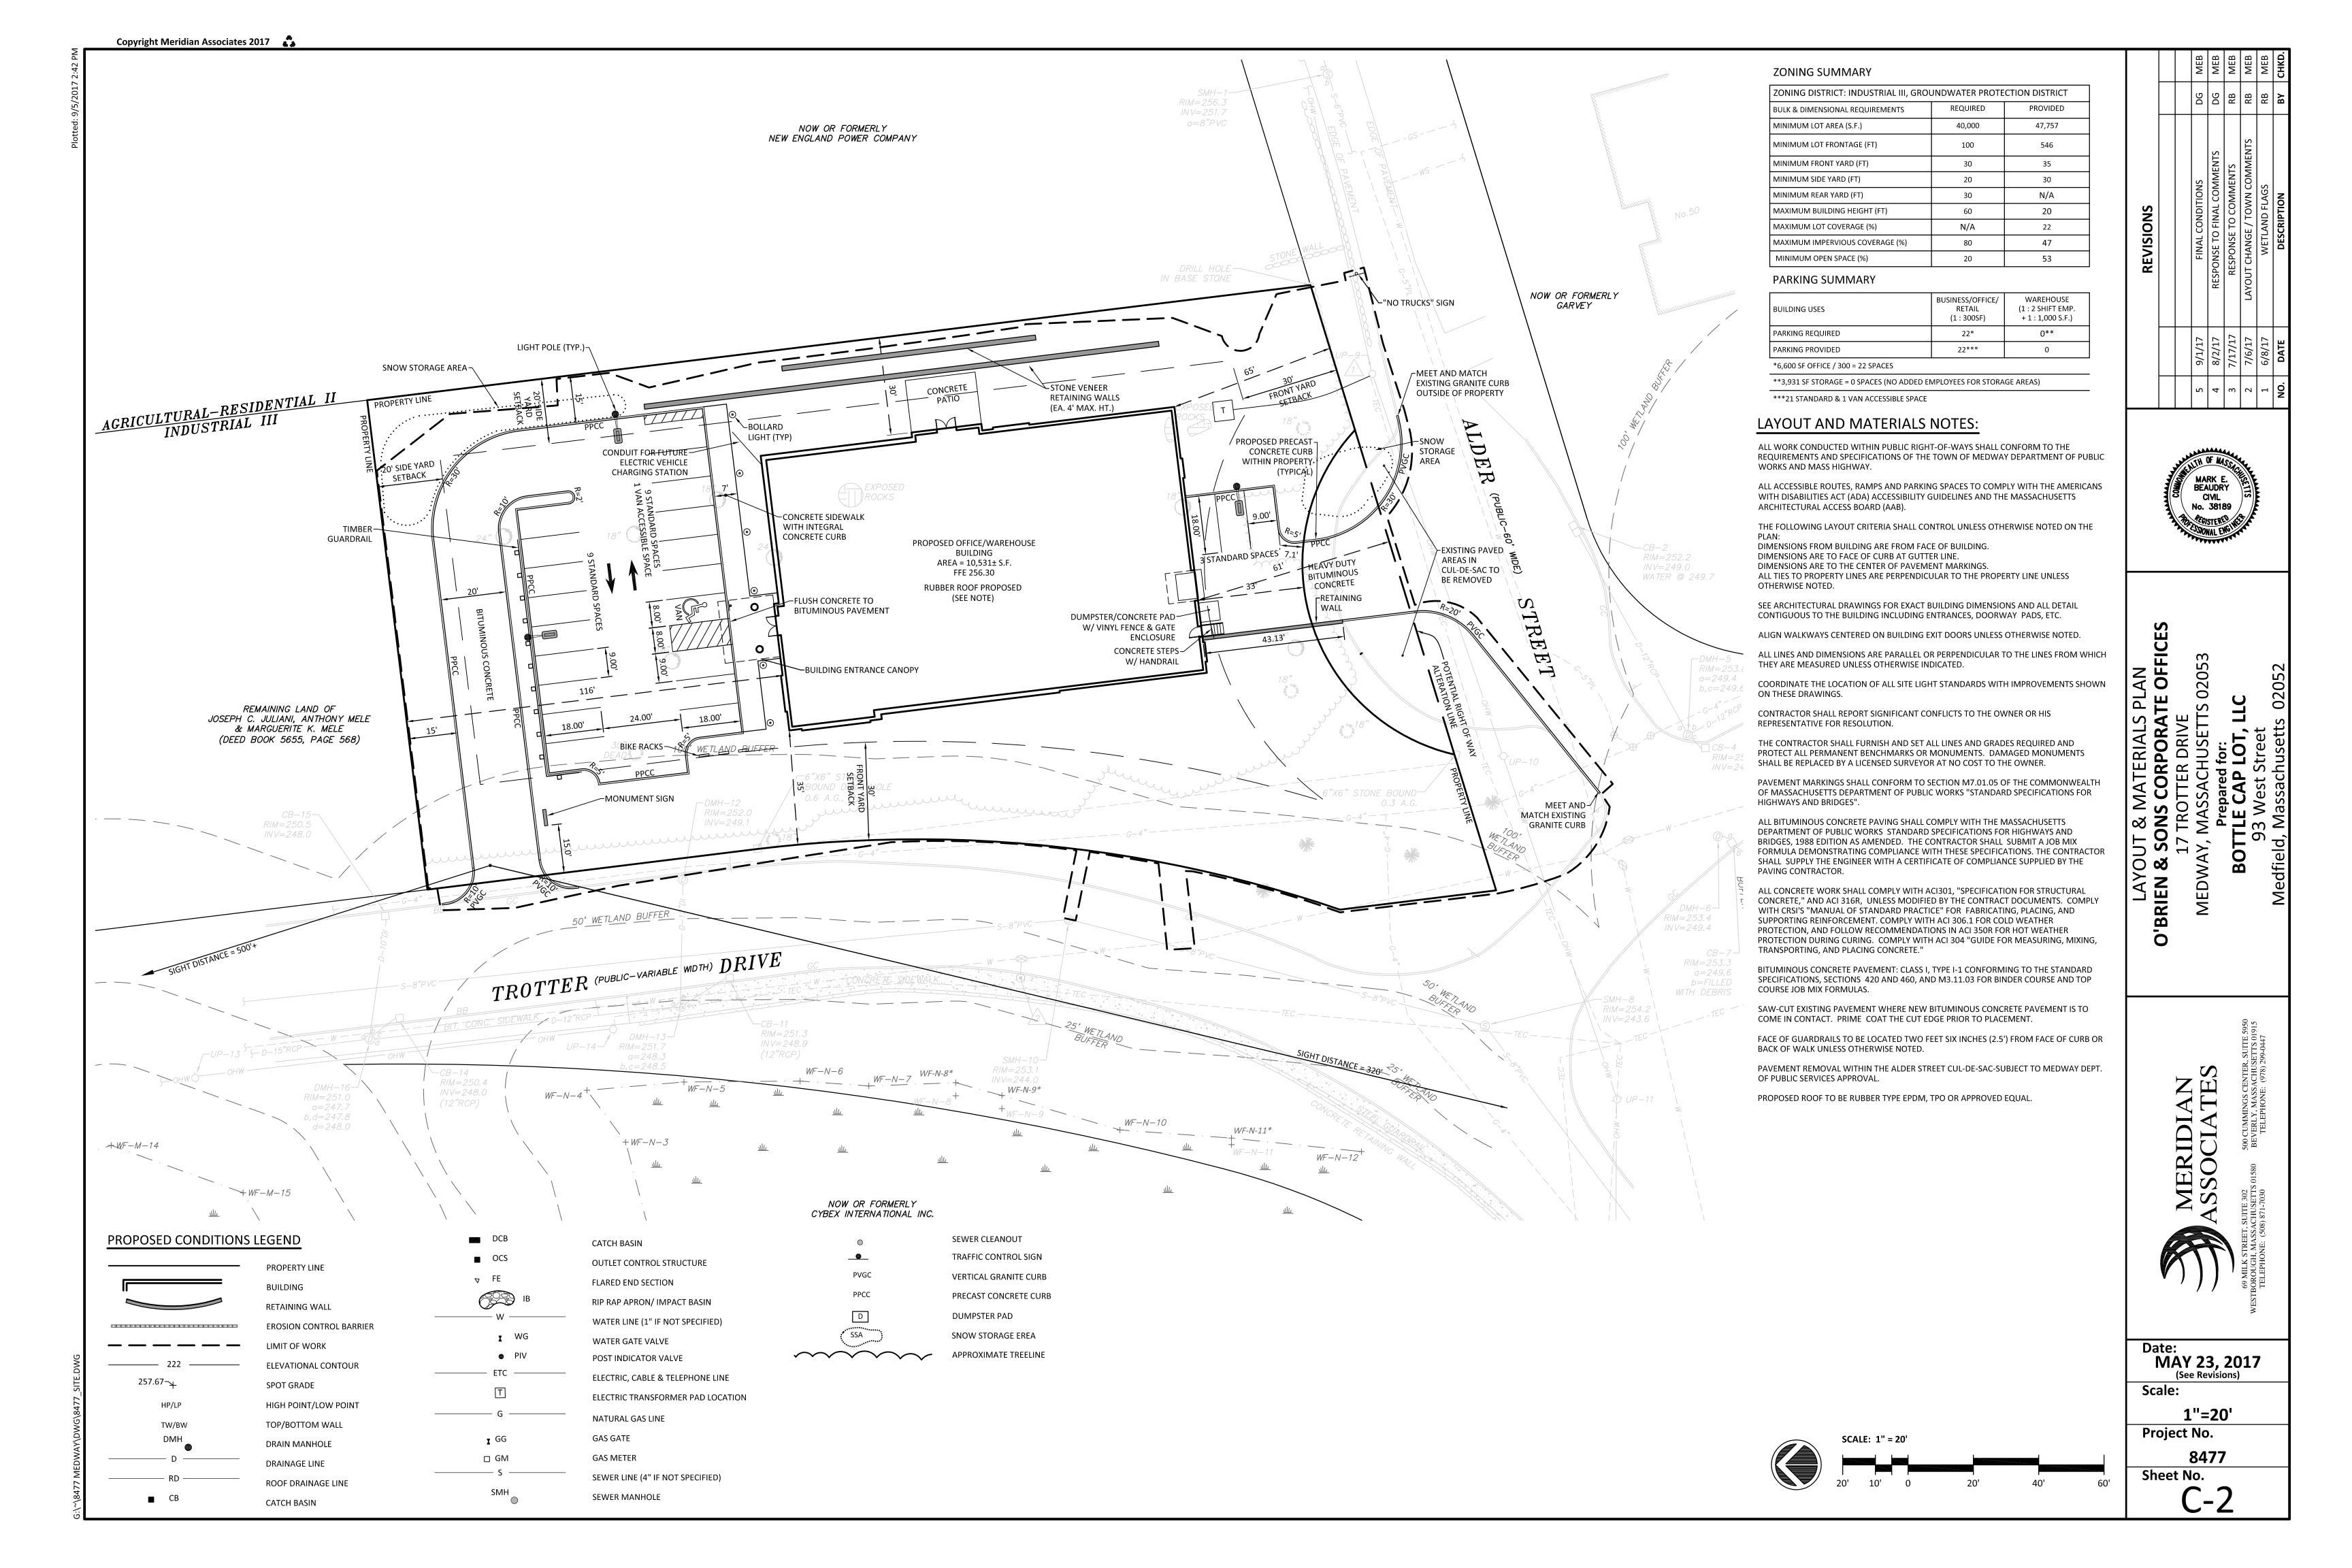

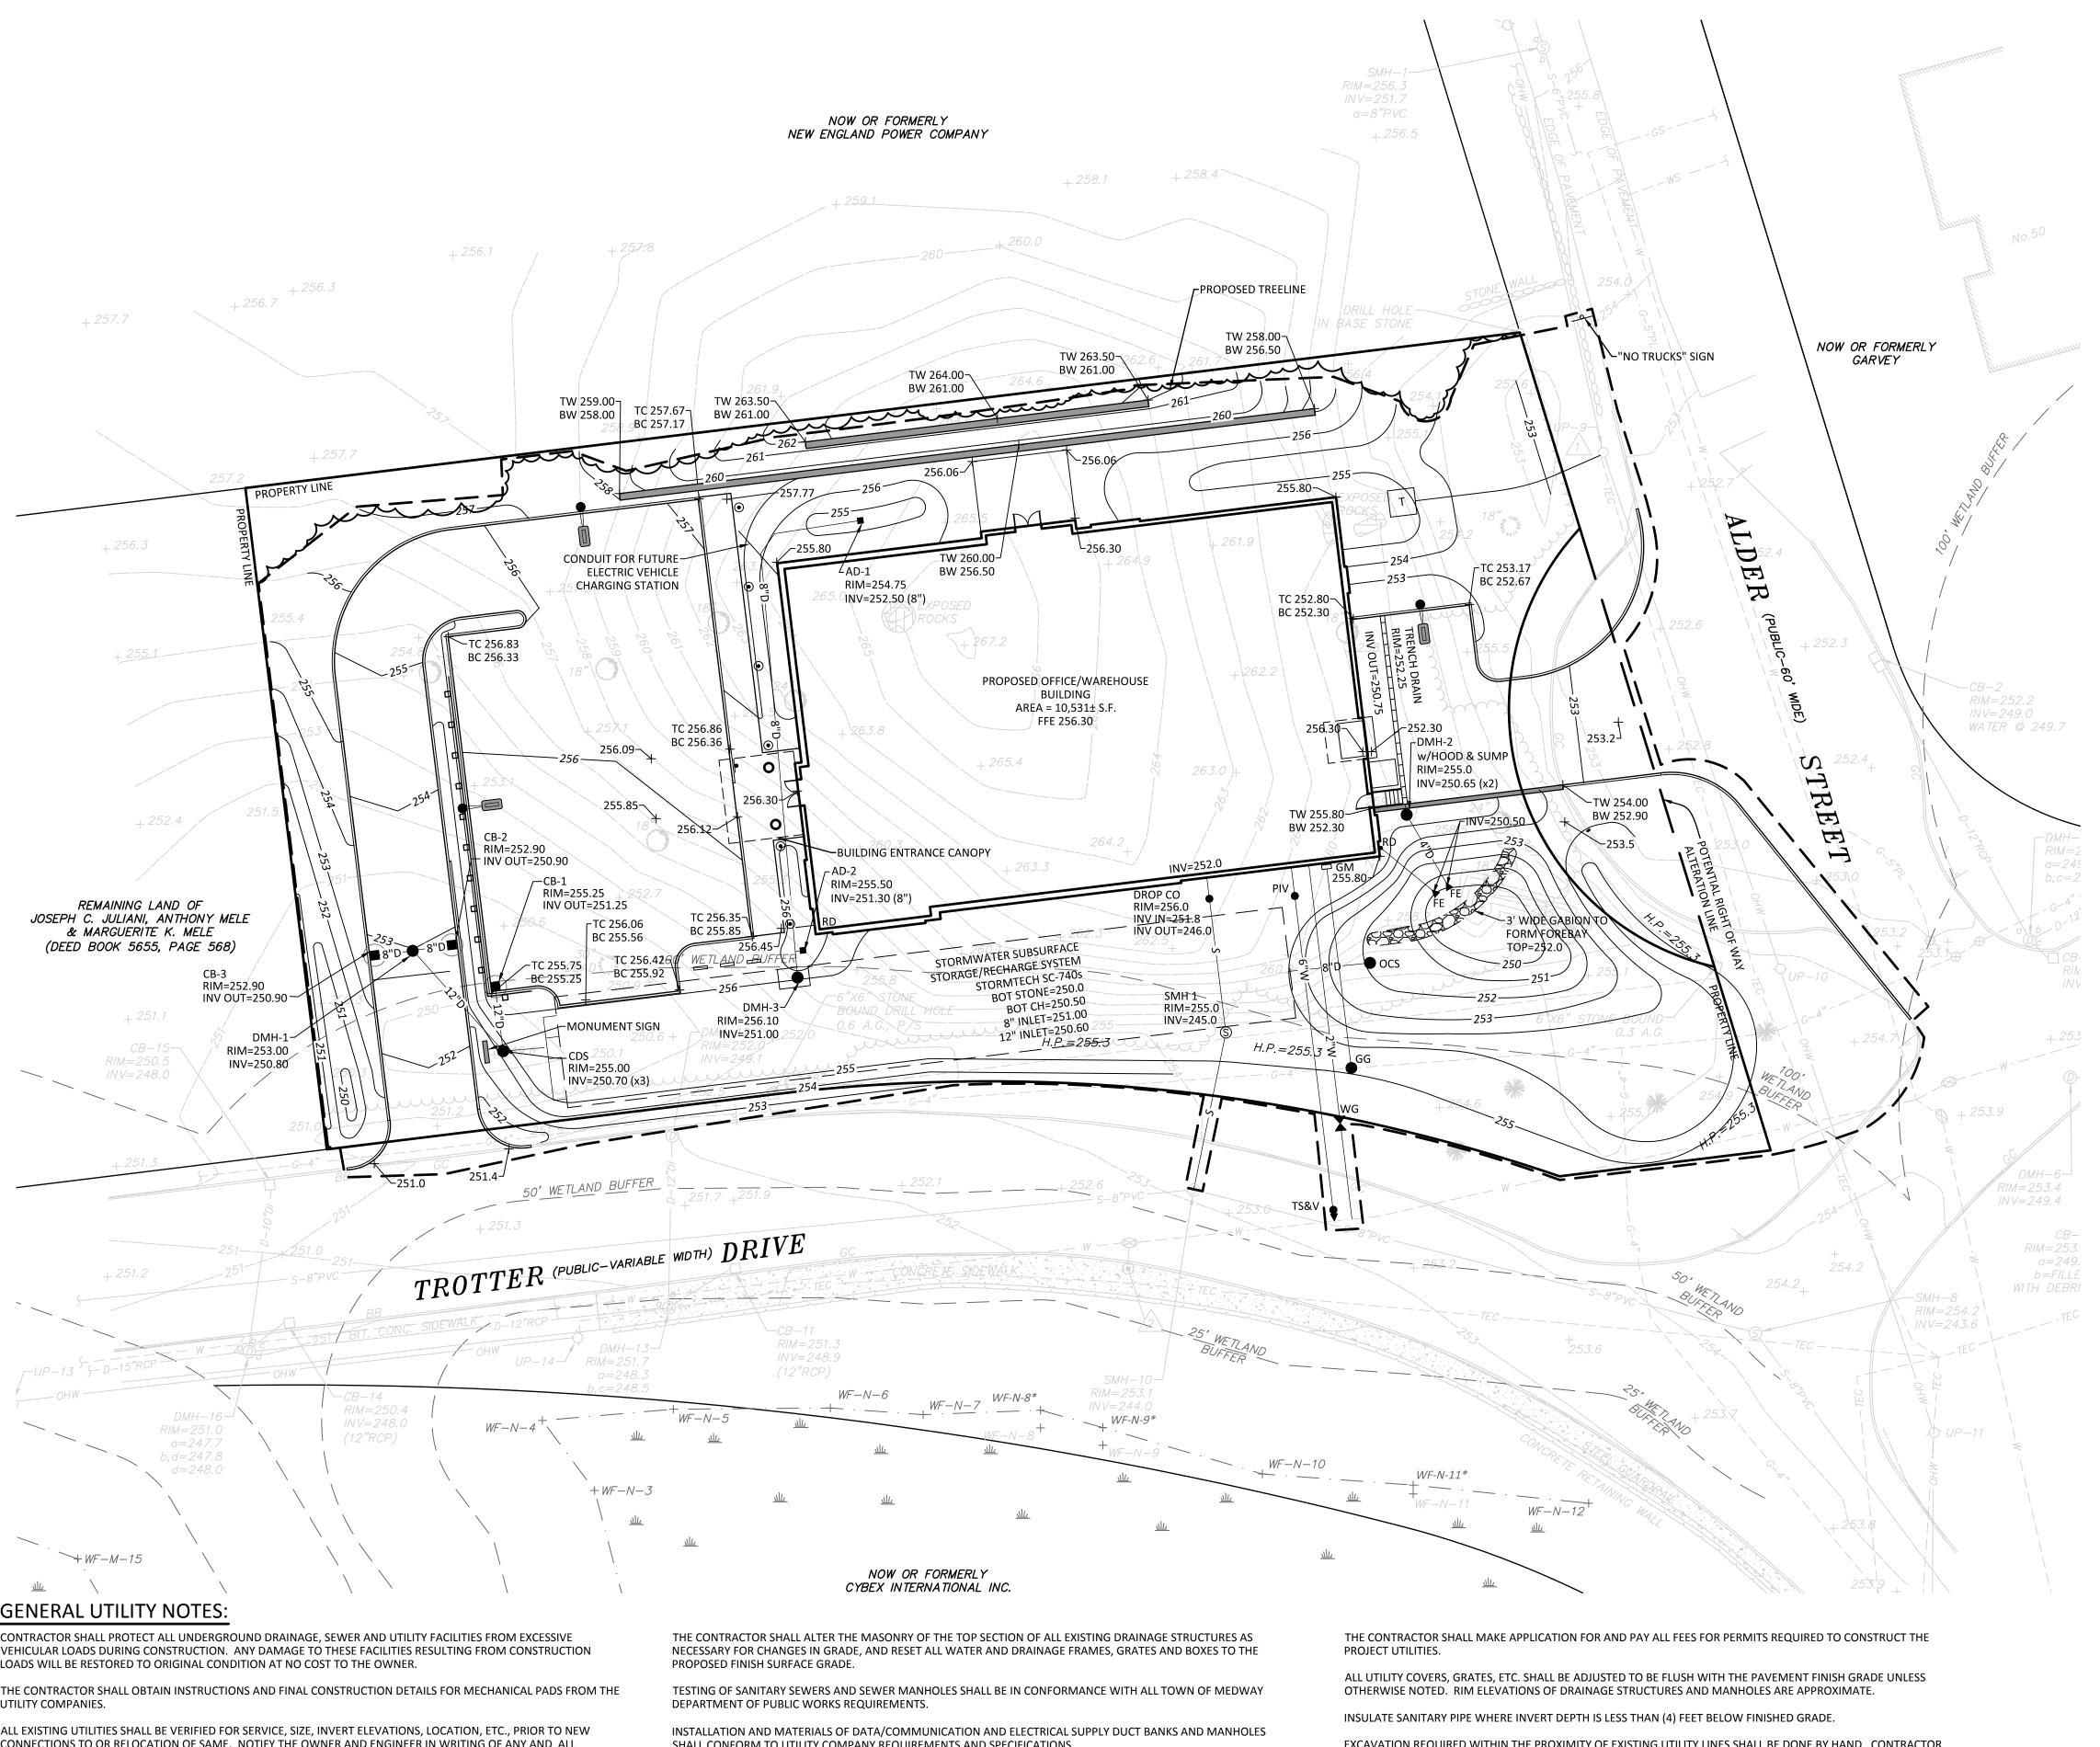

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CONNECTIONS TO OR RELOCATION OF SAME. NOTIFY THE OWNER AND ENGINEER IN WRITING OF ANY AND ALL DISCREPANCIES PRIOR TO COMMENCING ANY WORK. ALL EXISTING UTILITIES UNCOVERED OR DAMAGED DURING EXCAVATIONS AND CONSTRUCTION SHALL BE PLUGGED, CAPPED, RE-ROUTED OR RELOCATED AS DIRECTED BY THE OWNER SO AS NOT TO INTERRUPT THE OPERATION OF ANY OF THE EXISTING SYSTEMS.

TRENCH FOR PIPE SHALL BE EXCAVATED TO THE REQUIRED LINE AND GRADE AND OF SUFFICIENT WIDTH TO PERMIT THOROUGH TAMPING OF THE FILL MATERIAL UNDER THE HAUNCHES AND AROUND THE PIPE. SOFT OR UNSUITABLE MATERIAL ENCOUNTERED BELOW THE NORMAL BEDDING LINE OF THE PIPE SHALL BE REMOVED AS DIRECTED. REPLACED WITH CRUSHED STONE AND THOROUGHLY COMPACTED. THE BOTTOM OF THE TRENCH SHALL BE SHAPED TO CONFORM TO THE CURVATURE OF THE PIPE AND EXCAVATED FOR THE BELLS OF PIPES. THE TRENCH MAY BE RAISED OR LOWERED ONLY AS APPROVED BY THE ENGINEER. USE CONCRETE OR OTHER APPROVED SUPPORT UNDER EXISTING PIPES PASSING THROUGH THE TRENCH.

PIPE SHALL BE LAID TRUE TO THE SPECIFIED LINES AND GRADES.

NO BACKFILLING OF ANY UTILITY SHALL TAKE PLACE UNTIL ALL NECESSARY INSPECTIONS AND TESTING HAS OCCURRED AND HAS BEEN APPROVED. A COPY OF ALL TEST RESULTS ARE TO BE SUPPLIED TO THE ENGINEER UPON RECEIPT.

SHALL CONFORM TO UTILITY COMPANY REQUIREMENTS AND SPECIFICATIONS.

PROVIDE UNDERGROUND ELECTRIC CONDUIT FOR SITE LIGHTS AS APPROPRIATE.

THE CONTRACTOR SHALL COORDINATE ALL WORK ON UTILITY DUCTS WITH THE APPROPRIATE UTILITY COMPANY INCLUDING WORK BY UTILITY COMPANY FORCES, SERVICE CONNECTIONS AND INSPECTIONS.

PRE-CAST CONCRETE STRUCTURES INCLUDING TANKS, BARREL SECTIONS, CATCHBASINS AND BASES SHALL CONFORM TO ASTM C478 AND AASHTO HS20-44. PLACEMENT SHALL BE IN ACCORDANCE WITH MANUFACTURER INSTRUCTIONS. ALL PRE-CAST STRUCTURES INCLUDING JOINTS, SEALS, OPENINGS, ETC. MUST BE WATERTIGHT. BITUMINOUS DAMP-PROOFING SHALL BE PROVIDED ON THE EXTERIOR WALLS OF ALL SANITARY SEWER AND WATER QUALITY INLET STRUCTURES.

UTILITY / MANHOLE INSTALLATIONS SHALL CONFORM TO UTILITY COMPANY REQUIREMENTS.


ANY WORK NOT MEETING THE APPROVED STANDARDS SHALL BE IMMEDIATELY REMOVED AND REPLACED AT THE FULL RESPONSIBILITY AND COST/EXPENSE OF THE CONTRACTOR.

EXCAVATION REQUIRED WITHIN THE PROXIMITY OF EXISTING UTILITY LINES SHALL BE DONE BY HAND. CONTRACTOR

SHALL REPAIR ANY DAMAGE TO EXISTING UTILITY LINES OR STRUCTURES INCURRED DURING CONSTRUCTION OPERATIONS AT NO COST TO THE OWNER.

UNLESS OTHERWISE INDICATED, ABANDONED EXISTING UTILITY LINES SHALL BE CAPPED AND ABANDONED IN PLACE UNLESS THEY CONFLICT WITH PROPOSED IMPROVEMENTS. CAP REMAINING PORTIONS WHERE PARTIALLY REMOVED.

CAP ALL PROPOSED UTILITY STUBS AS APPROPRIATE.

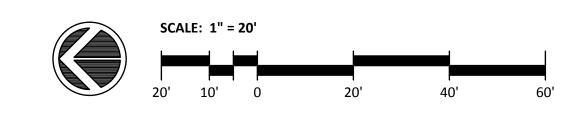

LEGEND:

SEE SHEET C-3 FOR LEGEND

NOTE:

SITE IS LOCATED WITHIN A ZONE II/GROUNDWATER PROTECTION DISTRICT

GRADING NOTES:

THE CONTRACTOR SHALL VERIFY EXISTING GRADES IN THE FIELD AND REPORT ANY DISCREPANCIES IMMEDIATELY TO THE OWNER OR HIS REPRESENTATIVE.

EXCAVATION REQUIRED WITHIN THE PROXIMITY OF EXISTING UTILITY LINES SHALL BE DONE BY HAND. CONTRACTOR SHALL REPAIR ANY DAMAGE TO EXISTING UTILITY LINES OR STRUCTURES INCURRED DURING CONSTRUCTION OPERATIONS AT NO COST TO THE OWNER.

PITCH EVENLY BETWEEN SPOT GRADES. GRADE ALL AREAS TO DRAIN. ALL PAVED AREAS MUST PITCH TO DRAIN AT A MINIMUM OF 1/8" PER FOOT UNLESS OTHERWISE SPECIFIED. ANY DISCREPANCIES NOT ALLOWING THIS MINIMUM PITCH SHALL BE REPORTED TO THE OWNER OR HIS REPRESENTATIVE PRIOR TO CONTINUING WORK.

ALL SITEWORK SHALL CONFORM TO THE CONTRACT DOCUMENTS AND SHALL COMPLY WITH APPLICABLE CODES AND REGULATIONS. AND THE STORMWATER POLLUTION PREVENTION PLAN (SWPPP) PREPARED FOR THE PROJECT.

A GEOTECHNICAL ENGINEER MAY BE RETAINED BY THE OWNER TO OBSERVE PERFORMANCE OF WORK, FOR CONFORMANCE WITH THESE CONTRACT DOCUMENTS, IN CONNECTION WITH EXCAVATING, TRENCHING, FILLING,

DURING THE PROGRESS OF THE WORK, THE CONTRACTOR MAY BE REQUIRED TO EXCAVATE ADDITIONAL TEST PITS FOR THE PURPOSE OF LOCATING UNDERGROUND UTILITIES OR STRUCTURES AS AN AID IN ESTABLISHING THE PRECISE LOCATION OF NEW WORK. THIS WORK IS TO BE PERFORMED AT NO ADDITIONAL COST TO THE OWNER. TEST PITS

PROTECT STRUCTURES, UTILITIES, SIDEWALKS, PAVEMENTS AND OTHER FACILITIES FROM DAMAGE CAUSED BY SETTLEMENT, LATERAL MOVEMENT, UNDERMINING, WASHOUT AND OTHER HAZARDS CREATED BY CONTRACTOR

FOR EXCAVATION, GRADING, OR IMPROVEMENT SHALL BE CLEARED AND GRUBBED. WITHIN THE CLEARING AND GRUBBING AREA, REMOVE ALL TREES, SHRUBS AND ROOTS UNLESS DESIGNATED OTHERWISE. CLEARING SHALL INCLUDE THE FELLING, CUTTING AND OFF-SITE DISPOSAL OF ALL TREES, SHRUBS, STUMPS AND VEGETATIVE DEBRIS PRODUCED THROUGH THE CLEARING OPERATIONS.

FILL DEPRESSIONS CAUSED BY TEST PITS AND CLEARING AND GRUBBING OPERATIONS WITH SATISFACTORY SOIL MATERIAL UNLESS FURTHER EXCAVATION OR EARTHWORK IS INDICATED.

THE CONTRACTOR SHALL PREVENT SURFACE WATER AND SUBSURFACE OR GROUNDWATER FROM FLOWING INTO EXCAVATIONS OR EARTHWORK AREAS WHICH WOULD CAUSE FLOODING OF THE PROJECT SITE AND SURROUNDING AREA, OR SOFTENING OR LOOSENING OF THE SOIL AT EXCAVATION OR EARTHWORK SUB-GRADES.

DEWATERING SYSTEMS AND DRAINAGE OF EXCAVATIONS TO PERMIT CONSTRUCTION TO PROCEED "IN THE DRY". THE CONTRACTOR SHALL ASSUME ALL RESPONSIBILITY FOR THE ADEQUACY OF THE METHODS, MATERIALS AND FOUIPMENT EMPLOYED. THE CONTRACTOR SHALL BEAR THE FULL COST OF PROVIDING ALL NECESSARY DEWATERING

THE CONTRACTOR SHALL PROHIBIT SEEPAGE, GROUNDWATER FLOW OR SURFACE INFILTRATION AND RUNOFF FROM UNDERMINING OR OTHERWISE DAMAGING ADJACENT STRUCTURES AND UTILITIES.

THE CONTRACTOR SHALL COLLECT AND DISPOSE OF WATER FROM ALL SYSTEMS IN ACCORDANCE WITH THE SWPPP AND WITH FEDERAL, STATE AND LOCAL CODES, ORDINANCES AND REGULATIONS AND OBTAIN ALL NECESSARY PERMITS. ANY WATER PUMPED FROM EXCAVATIONS WILL BE CONVEYED BY HOSE TO AN UPLAND AREA AND DISCHARGED INTO HAYBALE CORRALS OR SEDIMENTATION BAGS.

PAVING, CONCRETE WORK AND BASE COURSE PREPARATION SHALL BE DONE ONLY AFTER EXCAVATION AND CONSTRUCTION WORK WHICH MIGHT INJURE THEM HAS BEEN COMPLETED. DAMAGE CAUSED DURING CONSTRUCTION SHALL BE REPAIRED BEFORE ACCEPTANCE.

PAVEMENT OR BASE MATERIALS SHALL NOT BE PLACED ON A MUDDY OR FROZEN SUBGRADE.

ESTABLISHMENT OF GRADES, GRADE CONTROL, AND CONFORMANCE TO REQUIRED GRADE TOLERANCES SHALL BE THE RESPONSIBILITY OF THE CONTRACTOR.

PROTECT GRADED, FINISHED OR PAVED AREAS FROM DAMAGE AND KEEP THEM FREE OF TRASH AND DEBRIS RESULTING FROM CONSTRUCTION OPERATIONS. REPAIR AND RE-ESTABLISH GRADES IN SETTLED, ERODED AND

PAVEMENT EXCAVATED DURING UTILITY CONSTRUCTION, WHETHER ON THE SITE OR ADJACENT PROPERTIES, SHALL BE RESTORED AND MATCHED WITH EXACTLY THE SAME MATERIALS AND TOLERANCES AS PRIOR TO DISRUPTION, AT NO

ADDITIONAL COST TO THE OWNER, OR ADJACENT PROPERTY OWNERS. LAWN OR PLANTING AREAS EXCAVATED DURING UTILITY INSTALLATION, WHETHER ON THE SITE OR ADJACENT PROPERTIES, SHALL BE RE-GRADED AND RESTORED AT NO ADDITIONAL COST TO THE OWNER, OR ADJACENT

THE CONTRACTOR SHALL REMOVE, AND LEGALLY DISPOSE OF, ALL EXCAVATED MATERIAL CLASSIFIED AS SURPLUS OR UNSATISFACTORY FROM THE SITE.

STONE USED FOR MACHINE PLACED RIP-RAP SHALL BE REASONABLY WELL GRADED, HARD, DURABLE, ANGULAR IN SHAPE, RESISTANT TO WEATHERING AND FREE FROM ORGANIC MATERIAL. ROUNDED STONES OR BOULDERS ARE NOT ACCEPTABLE. THE MINIMUM WEIGHT OF THE STONE SHALL BE 155 POUNDS PER CUBIC FOOT. STONE SHALL BE PLACED IN CONFORMANCE WITH THE LINES, GRADES AND THICKNESSES SHOWN ON THE DRAWINGS.

AT ALL LOCATIONS WHERE EXISTING CURBING OR PAVEMENT ABUTS NEW CONSTRUCTION, THE EDGE OF THE EXISTING CURB OR PAVEMENT SHALL BE SAW CUT TO A CLEAN, SMOOTH EDGE. BLEND NEW PAVEMENT, CURBS AND EARTHWORK SMOOTHLY INTO EXISTING BY MATCHING LINES, GRADES AND JOINTS.

ALL RIP RAP STONE SHALL BE HAND CHINKED AND SHALL CONFORM TO MASSACHUSETTS HIGHWAY DEPARTMENT

BLEND NEW EARTHWORK SMOOTHLY INTO EXISTING.

DRAINAGE NOTES:

PROPERTY OWNERS.

MANHOLES SHALL BE 48-INCH DIAMETER (UNLESS OTHERWISE SPECIFIED). CAST-IN-PLACE BASES SHALL BE USED WHERE MANHOLES ARE CONSTRUCTED OVER EXISTING PIPES.

FRAMES AND COVERS FOR DRAINAGE STRUCTURES AND SANITARY SEWER STRUCTURES SHALL PROVIDE A 24-INCH MINIMUM CLEAR OPENING AND SHALL BE LEBARON TYPE LK110 OR APPROVED EQUAL.

DRAINAGE STRUCTURE COVERS SHALL HAVE THE WORD "DRAIN" CENTERED ON THE COVER IN 3-INCH HIGH LETTERS. SANITARY SEWER STRUCTURE COVERS SHALL HAVE THE WORD "SEWER" CENTERED ON THE COVER IN 3-INCH HIGH

SINGLE CATCH BASIN FRAMES AND GRATES SHALL BE LEBARON TYPE LF 248-2 OR AS REQUIRED BY TOWN OF MEDWAY

DOUBLE CATCH BASIN FRAMES SHALL BE LABARON ONE-PIECE LV2448-1 FRAMES OR APPROVED EQUAL. FOR DOUBLE CATCH BASIN GRATES, USE TWO LEBARON TYPE LF 248-2 OR APPROVED EQUAL.

FRAMES, GRATES AND COVERS SHALL BE SET FIRM AND TRUE TO GRADE, ADJUST FOR GRADE WITH BRICK MASONRY. ALL ON-SITE DRAIN LINES SHALL BE SMOOTH INTERIOR WALLED CORRUGATED POLYETHYLENE PIPE UNLESS OTHERWISE

FLARED END SECTIONS SHALL BE PIPE MANUFACTURER STANDARD CONSTRUCTED FROM THE SAME MATERIAL AS THE PIPE

INSTALL PIPE AND FLARED ENDS IN STRICT ACCORDANCE WITH PIPE MANUFACTURER INSTRUCTIONS.

ALL DRAIN LINES SHOWN SHALL BE 12" DIAMETER UNLESS OTHERWISE NOTED.



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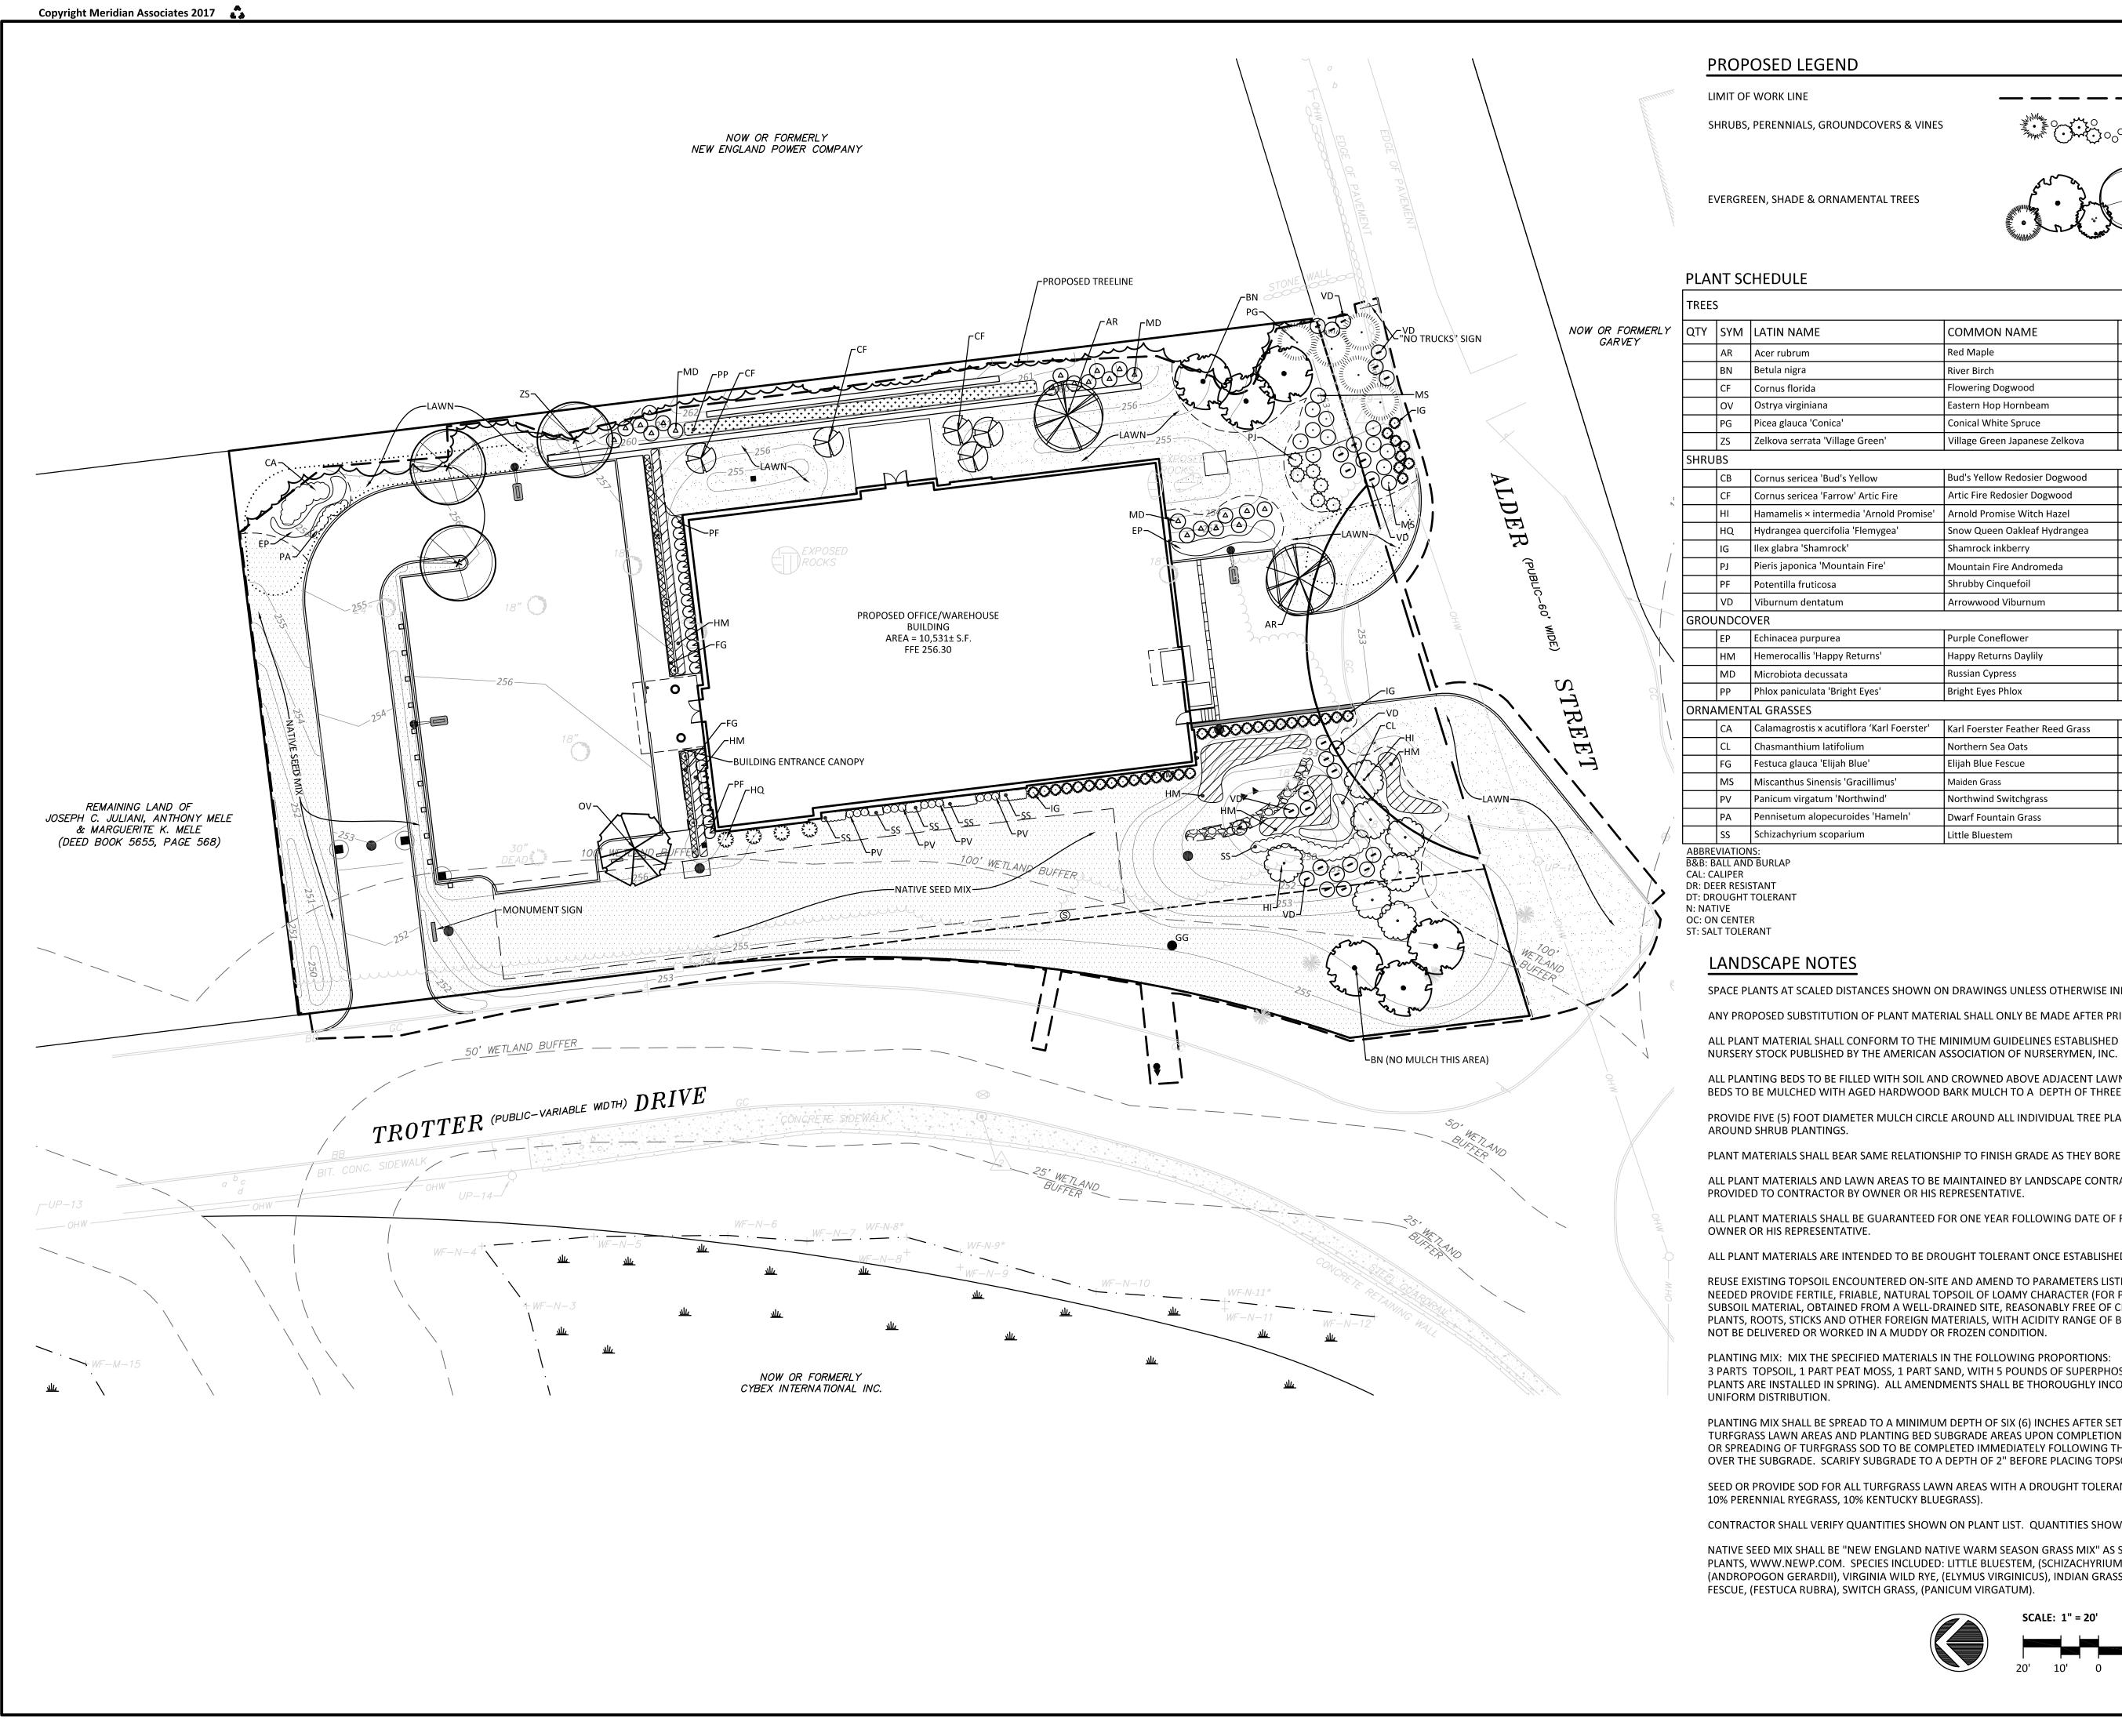
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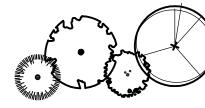
Scale:

1"=20' Project No.

Sheet No.







	TREES	TREES										
Y	QTY	SYM	LATIN NAME	COMMON NAME	SIZE	NOTES						
		AR	Acer rubrum	Red Maple	3"-3.5" Cal., B&B	N - Fall color						
		BN	Betula nigra	River Birch	10'-12' Ht., B&B	DR - DT - N						
		CF	Cornus florida	Flowering Dogwood	2"-2.5" Cal., B&B	DR - N						
		ov	Ostrya virginiana	Eastern Hop Hornbeam	2.5"-3" Cal., B&B	DR - DT - N						
		PG	Picea glauca 'Conica'	Conical White Spruce	3.5'-4' Ht., #10 Pot,	DR - N						
		ZS	Zelkova serrata 'Village Green'	Village Green Japanese Zelkova	2.5" Cal. B&B							

SHRU	BS					
	СВ	Cornus sericea 'Bud's Yellow	Bud's Yellow Redosier Dogwood	24"-30" Ht., #3 Pot	DR - N - ST - 48" O.C. DR - N - ST - 36" O.C.	
	CF	Cornus sericea 'Farrow' Artic Fire	Artic Fire Redosier Dogwood	24"-30" Ht., #3 Pot		
	н	Hamamelis × intermedia 'Arnold Promise'	Arnold Promise Witch Hazel	24"-30" Ht., #10 Pot	DR - 10' O.C.	
	HQ	Hydrangea quercifolia 'Flemygea'	Snow Queen Oakleaf Hydrangea	30"-36" Ht., B&B	60" O.C.	
	IG	Ilex glabra 'Shamrock'	Shamrock inkberry	24"-30" Ht., B&B	DR - N - ST - 36" O.C.	
	PJ	Pieris japonica 'Mountain Fire'	Mountain Fire Andromeda	24"-30' Ht., #3 Pot	DR - 48" O.C.	
	PF	Potentilla fruticosa	Shrubby Cinquefoil	18"-24" Ht., #3 Pot	DR - DT - N - ST - 36" O.C.	
	VD	Viburnum dentatum	Arrowwood Viburnum	36"-60" Ht., #7 Pot	N - ST - 48" O.C.	
GROU	INDCO	OVER		•		
	EP	Echinacea purpurea	Purple Coneflower	#1 Pot	DR - DT - N - ST - 18" O.C.	
	нм	Hemerocallis 'Happy Returns'	Happy Returns Daylily	#1 Pot	ST - 15" O.C.	
	MD	Microbiota decussata	Russian Cypress	#5 Pot	ST - 48" O.C.	
	PP	Phlox paniculata 'Bright Eyes'	Bright Eyes Phlox	#1 Pot	DT - N - 12" O.C.	

	1				
	PP	Phlox paniculata 'Bright Eyes'	Bright Eyes Phlox	#1 Pot	DT - N - 12" O.C.
ORN/	MENT	AL GRASSES	,		
	CA	Calamagrostis x acutiflora 'Karl Foerster'	Karl Foerster Feather Reed Grass	#2 Pot	ST - 18" O.C.
	CL	Chasmanthium latifolium	Northern Sea Oats	#1 Pot	ST - 18" O.C.
	FG	Festuca glauca 'Elijah Blue'	Elijah Blue Fescue	#1 Pot	DT - ST - 12" O.C.
	MS	Miscanthus Sinensis 'Gracillimus'	Maiden Grass	#3 Pot	DT - 48" O.C.
	PV	Panicum virgatum 'Northwind'	Northwind Switchgrass	#3 Pot	DT - N - ST - 24" O.C.
	PA	Pennisetum alopecuroides 'Hameln'	Dwarf Fountain Grass	#2 Pot	DT - ST - 18" O.C.
	SS	Schizachyrium scoparium	Little Bluestem	#2 Pot	DR - DT - N - ST - 18" O.C.

SPACE PLANTS AT SCALED DISTANCES SHOWN ON DRAWINGS UNLESS OTHERWISE INDICATED.

ANY PROPOSED SUBSTITUTION OF PLANT MATERIAL SHALL ONLY BE MADE AFTER PRIOR APPROVAL OF LANDSCAPE ARCHITECT.

ALL PLANT MATERIAL SHALL CONFORM TO THE MINIMUM GUIDELINES ESTABLISHED BY THE AMERICAN STANDARD FOR

ALL PLANTING BEDS TO BE FILLED WITH SOIL AND CROWNED ABOVE ADJACENT LAWN OR IMPROVED AREAS. ALL PLANTING BEDS TO BE MULCHED WITH AGED HARDWOOD BARK MULCH TO A DEPTH OF THREE (3) INCHES.

PROVIDE FIVE (5) FOOT DIAMETER MULCH CIRCLE AROUND ALL INDIVIDUAL TREE PLANTINGS AND CONTINUOUS MULCH BED

PLANT MATERIALS SHALL BEAR SAME RELATIONSHIP TO FINISH GRADE AS THEY BORE TO GRADE IN THE NURSERY.

ALL PLANT MATERIALS AND LAWN AREAS TO BE MAINTAINED BY LANDSCAPE CONTRACTOR UNTIL FINAL WRITTEN ACCEPTANCE

ALL PLANT MATERIALS SHALL BE GUARANTEED FOR ONE YEAR FOLLOWING DATE OF FINAL WRITTEN ACCEPTANCE FROM THE

ALL PLANT MATERIALS ARE INTENDED TO BE DROUGHT TOLERANT ONCE ESTABLISHED.

REUSE EXISTING TOPSOIL ENCOUNTERED ON-SITE AND AMEND TO PARAMETERS LISTED BELOW. IF ADDITIONAL TOPSOIL IS NEEDED PROVIDE FERTILE, FRIABLE, NATURAL TOPSOIL OF LOAMY CHARACTER (FOR PLANTING MIX), WITHOUT ADMIXTURE OF SUBSOIL MATERIAL, OBTAINED FROM A WELL-DRAINED SITE, REASONABLY FREE OF CLAY, LUMPS, COARSE SANDS, STONES, PLANTS, ROOTS, STICKS AND OTHER FOREIGN MATERIALS, WITH ACIDITY RANGE OF BETWEEN PH 6.0 AND 6.8. TOPSOIL SHALL


3 PARTS TOPSOIL, 1 PART PEAT MOSS, 1 PART SAND, WITH 5 POUNDS OF SUPERPHOSPHATE/ CUBIC YARD OF MIXTURE (ONLY IF PLANTS ARE INSTALLED IN SPRING). ALL AMENDMENTS SHALL BE THOROUGHLY INCORPORATED INTO MIXTURE TO ASSURE

PLANTING MIX SHALL BE SPREAD TO A MINIMUM DEPTH OF SIX (6) INCHES AFTER SETTLING ON ALL DISTURBED AREAS, TURFGRASS LAWN AREAS AND PLANTING BED SUBGRADE AREAS UPON COMPLETION OF FINAL GRADING. SEEDING OPERATION OR SPREADING OF TURFGRASS SOD TO BE COMPLETED IMMEDIATELY FOLLOWING THE APPLICATION OF THE PLANTING MIX OVER THE SUBGRADE. SCARIFY SUBGRADE TO A DEPTH OF 2" BEFORE PLACING TOPSOIL.


SEED OR PROVIDE SOD FOR ALL TURFGRASS LAWN AREAS WITH A DROUGHT TOLERANT TURFGRASS SEED MIX (80% TALL FESCUE,

CONTRACTOR SHALL VERIFY QUANTITIES SHOWN ON PLANT LIST. QUANTITIES SHOWN ON PLANS SHALL GOVERN.

NATIVE SEED MIX SHALL BE "NEW ENGLAND NATIVE WARM SEASON GRASS MIX" AS SUPPLIED FROM NEW ENGLAND WETLAND PLANTS, WWW.NEWP.COM. SPECIES INCLUDED: LITTLE BLUESTEM, (SCHIZACHYRIUM SCOPARIUM), BIG BLUESTEM, (ANDROPOGON GERARDII), VIRGINIA WILD RYE, (ELYMUS VIRGINICUS), INDIAN GRASS, (SORGHASTRUM NUTANS), CREEPING RED

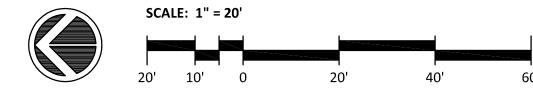

REVISIONS		FINAL CONDITIONS	RESPONSE TO FINAL COMMENTS	RESPONSE TO COMMENTS	LAYOUT CHANGE / TOWN COMMENTS	WETLAND FLAGS	DESCRIPTION	
		9/1/17	8/2/17	7/17/17	7/6/17	6/8/17	DATE	

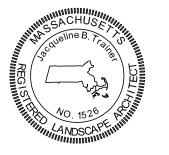


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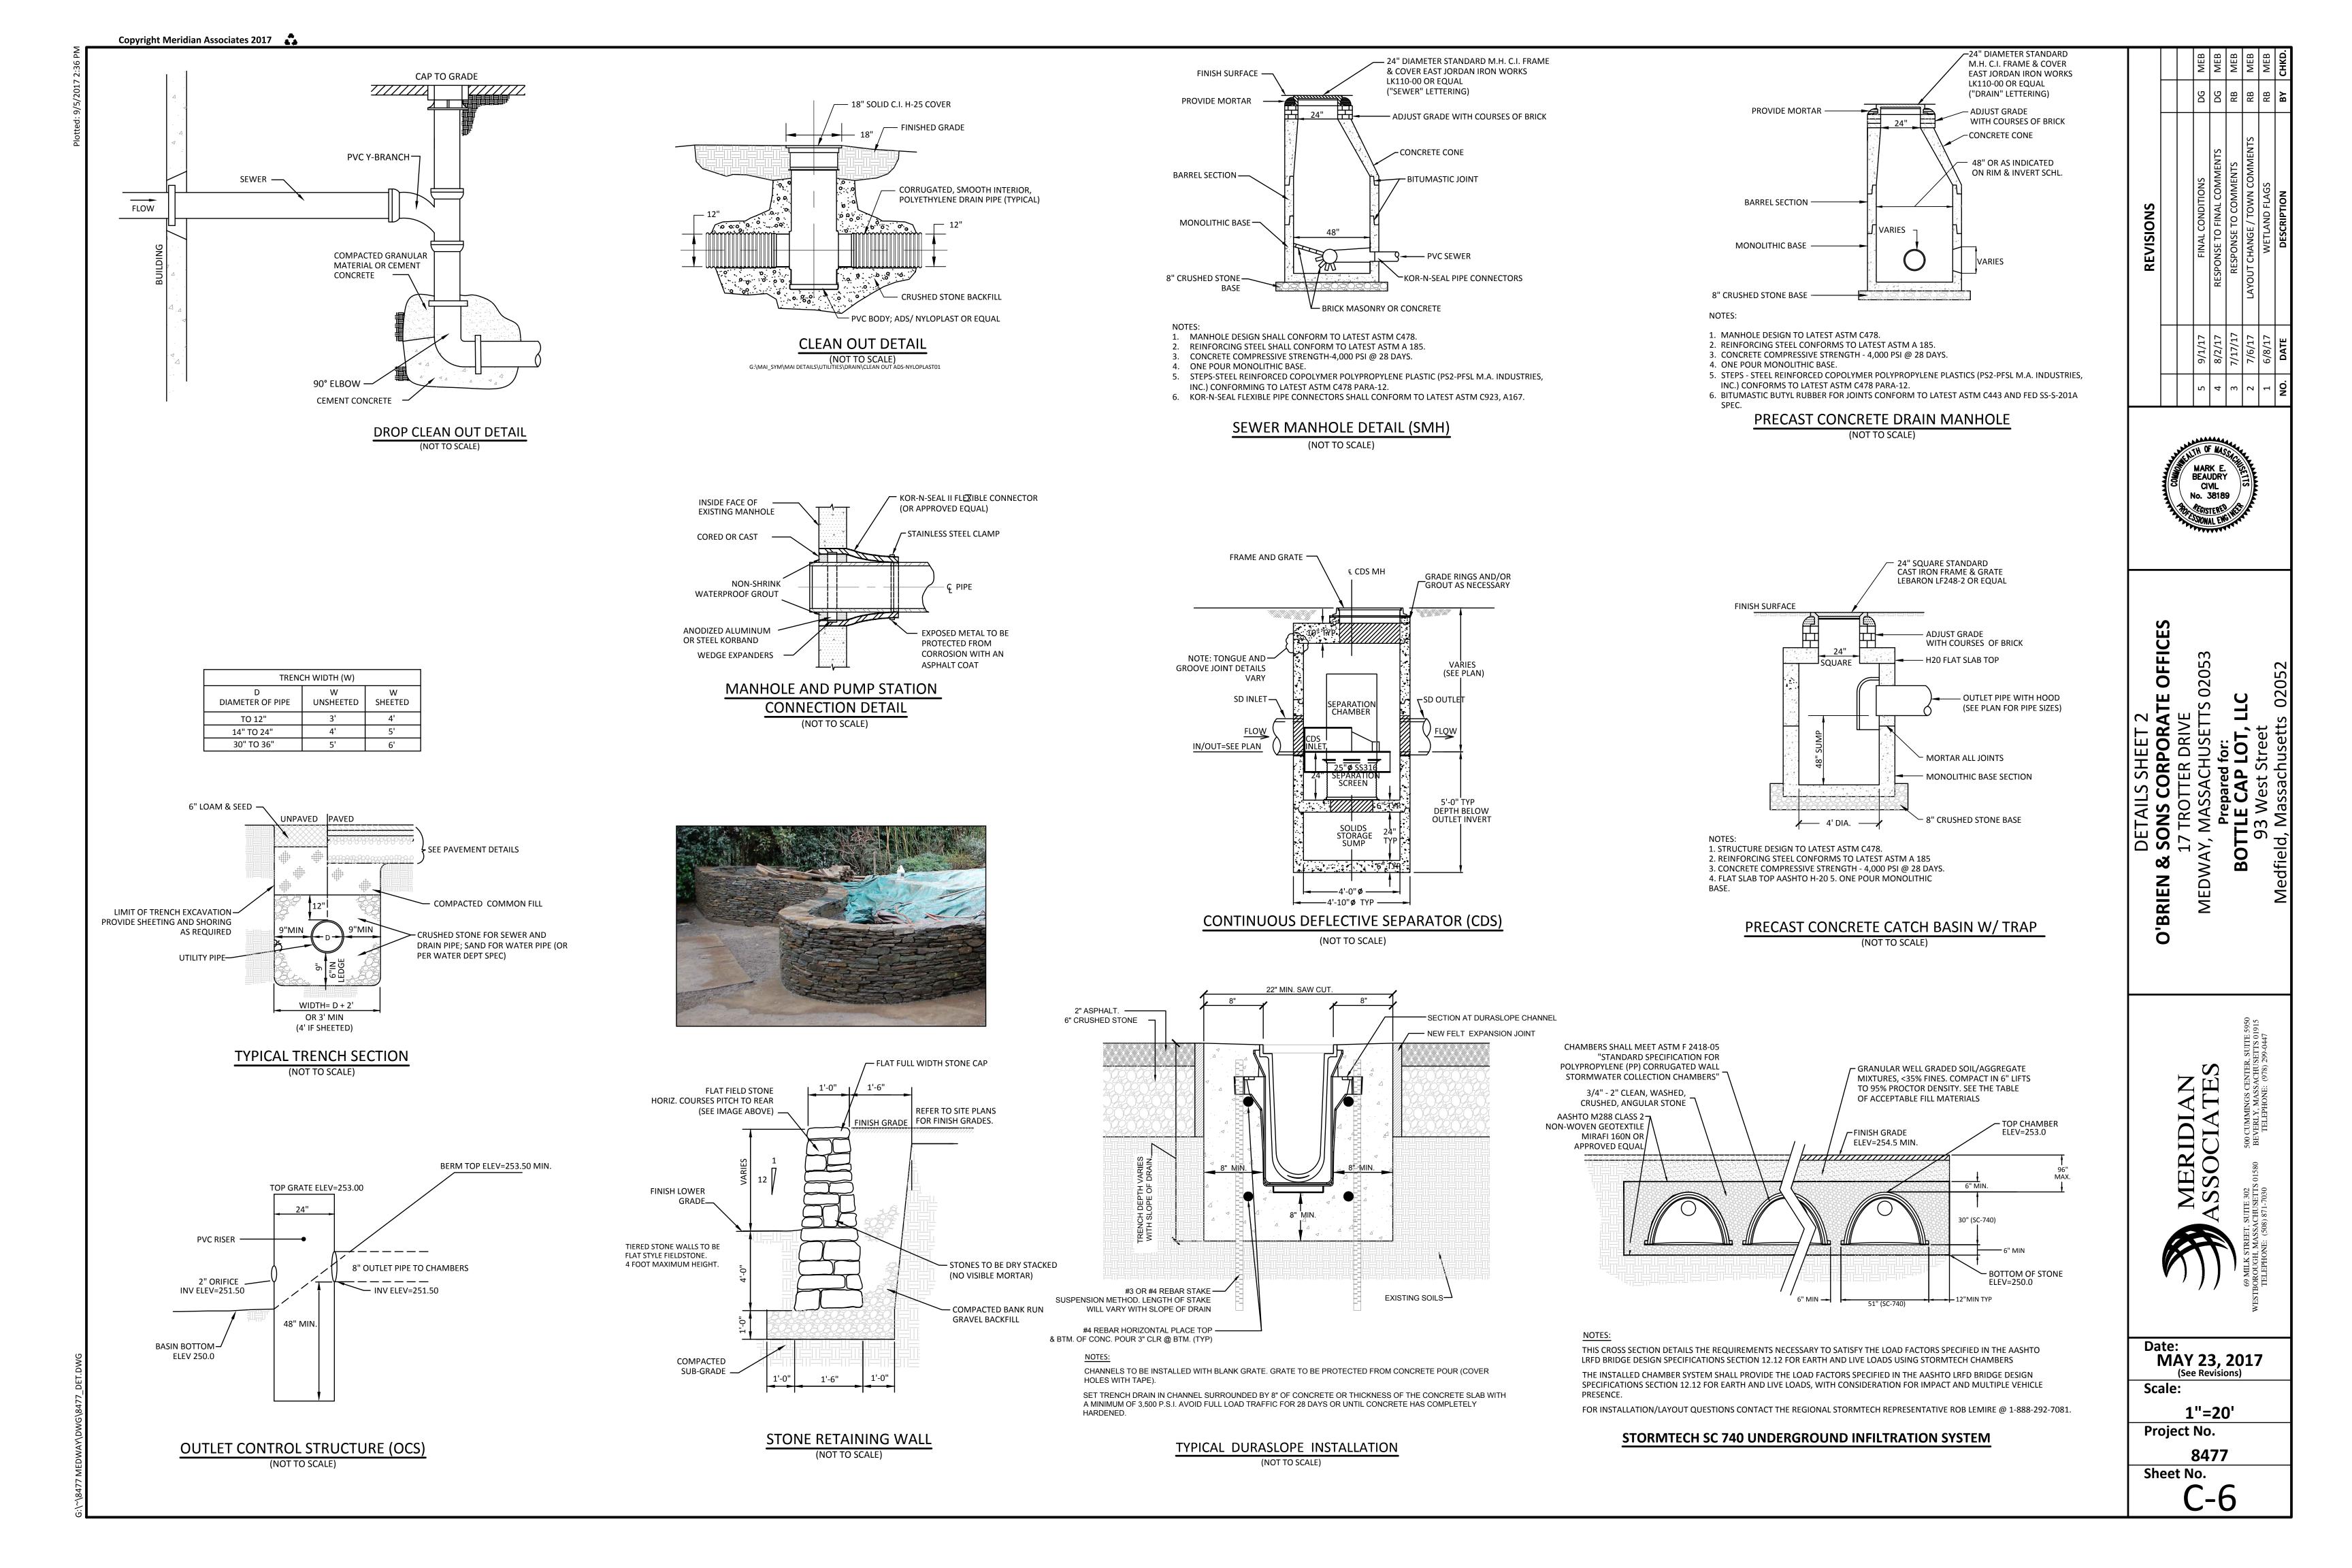
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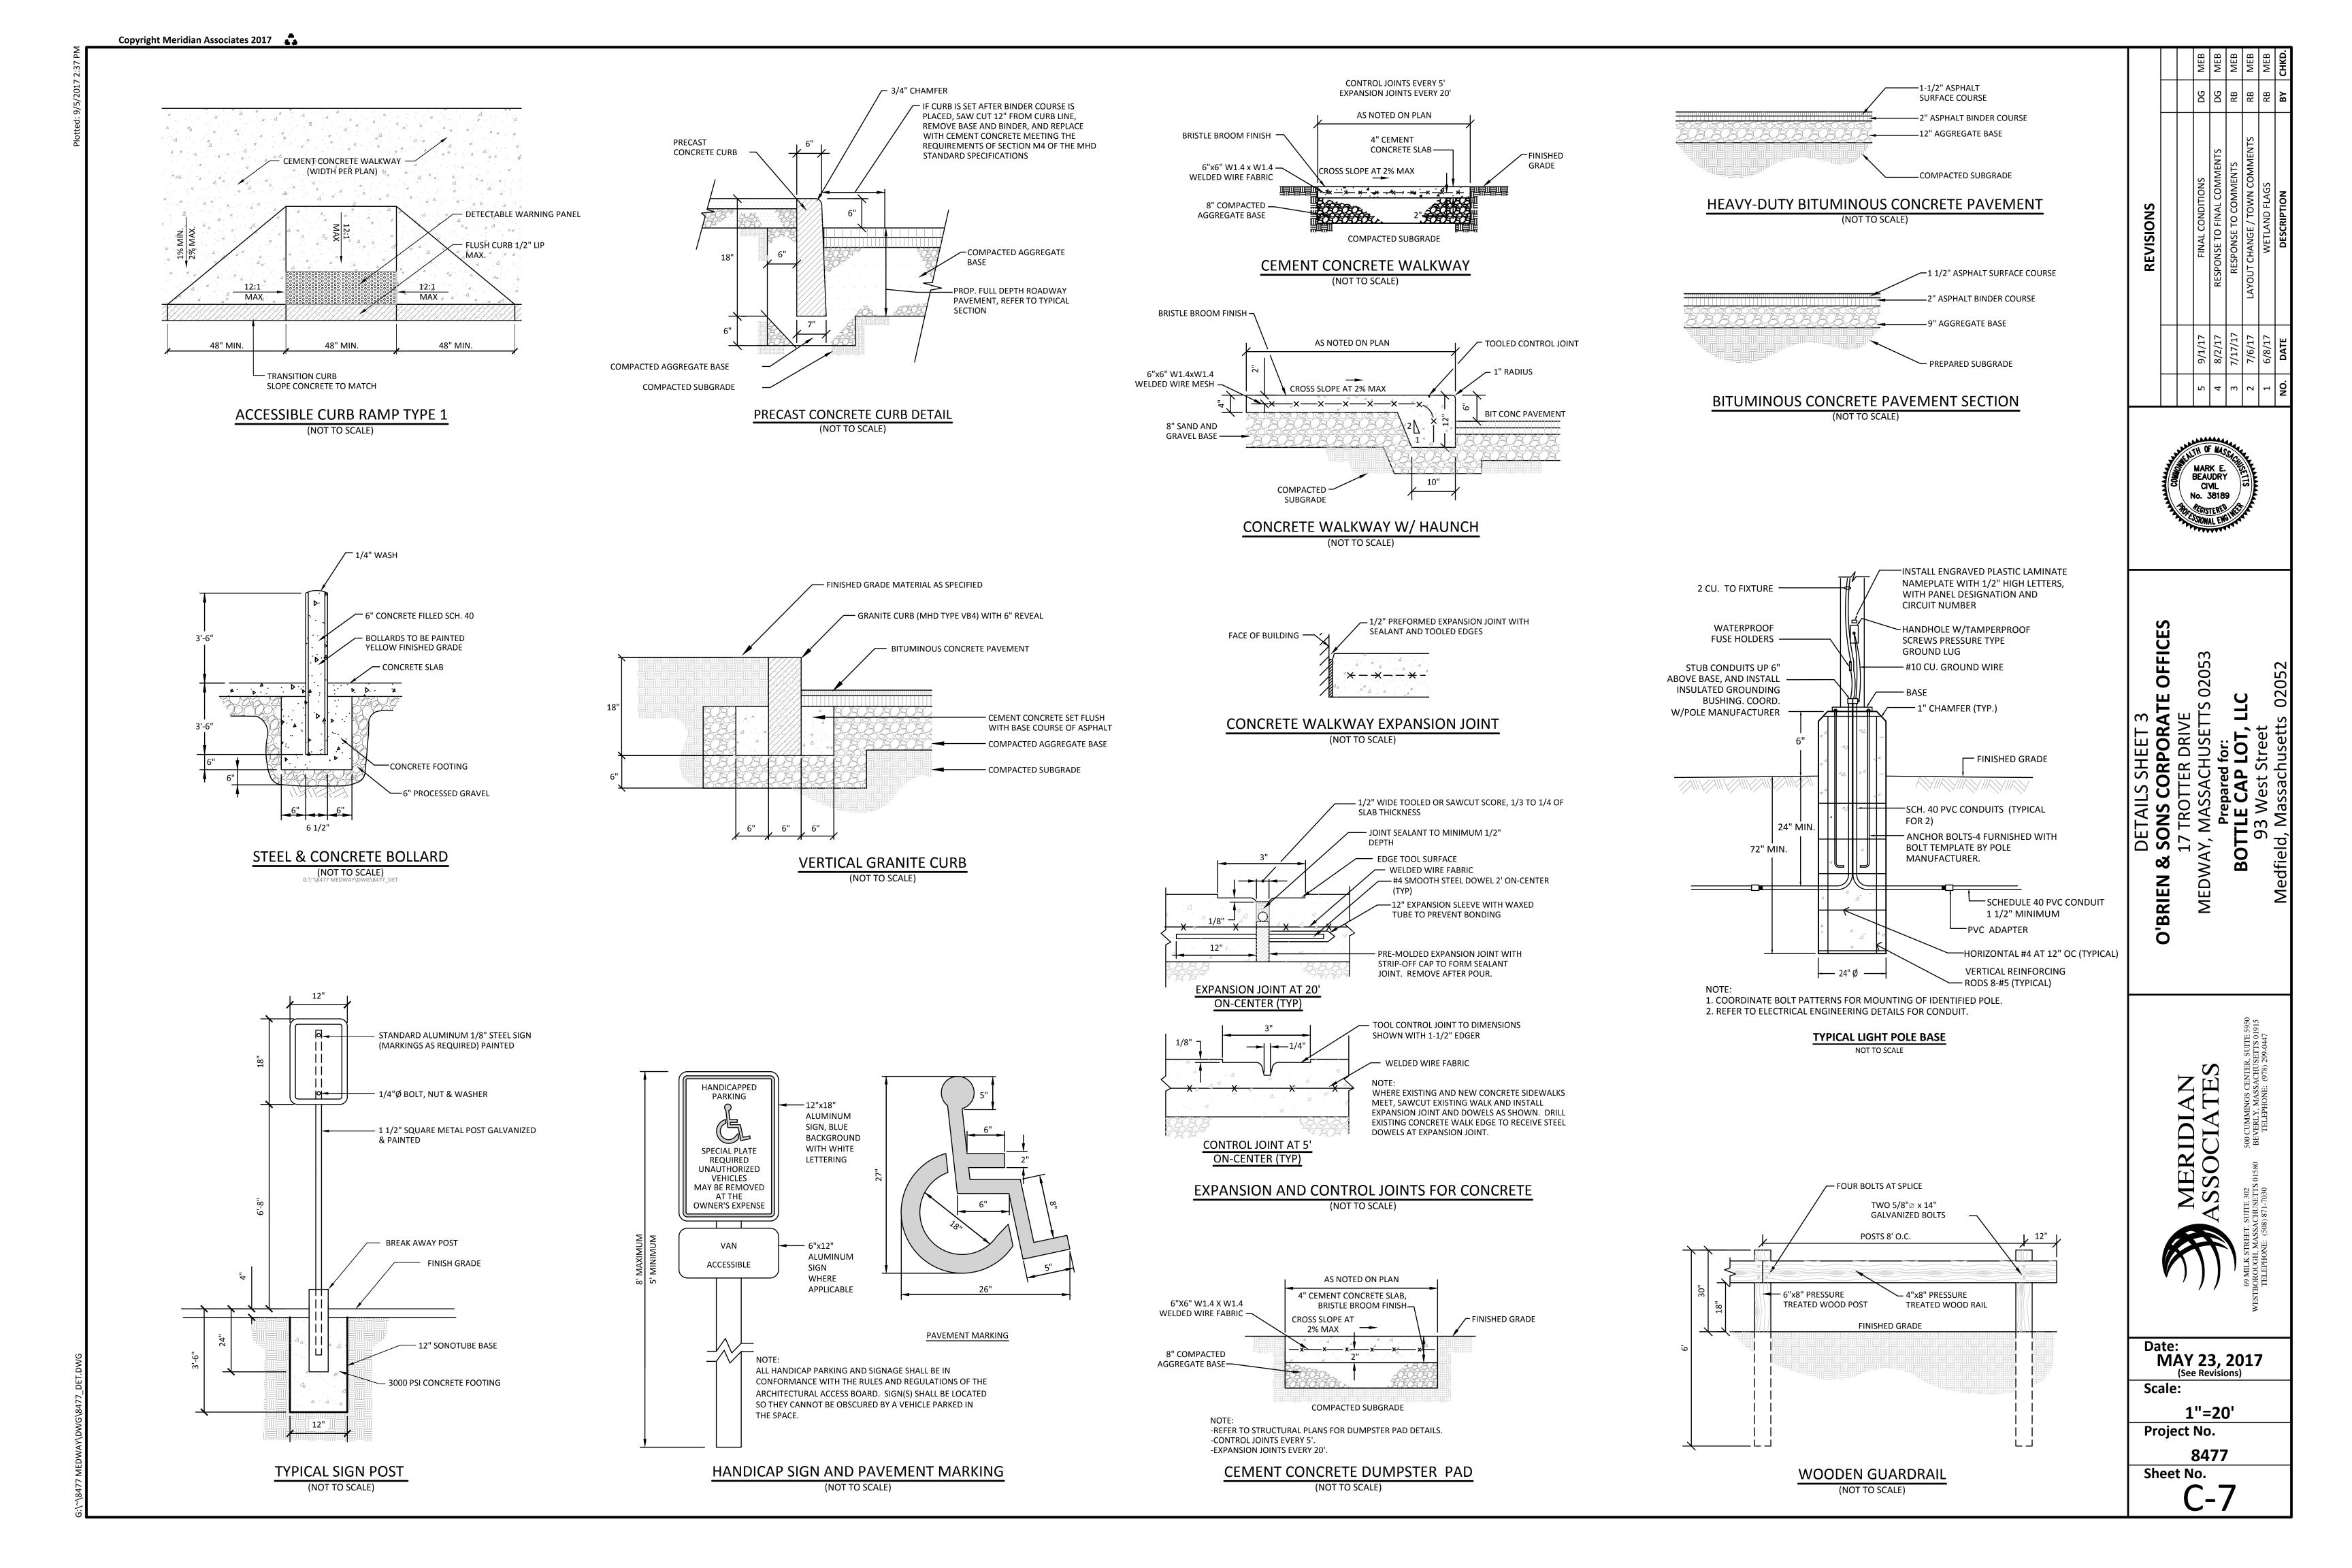
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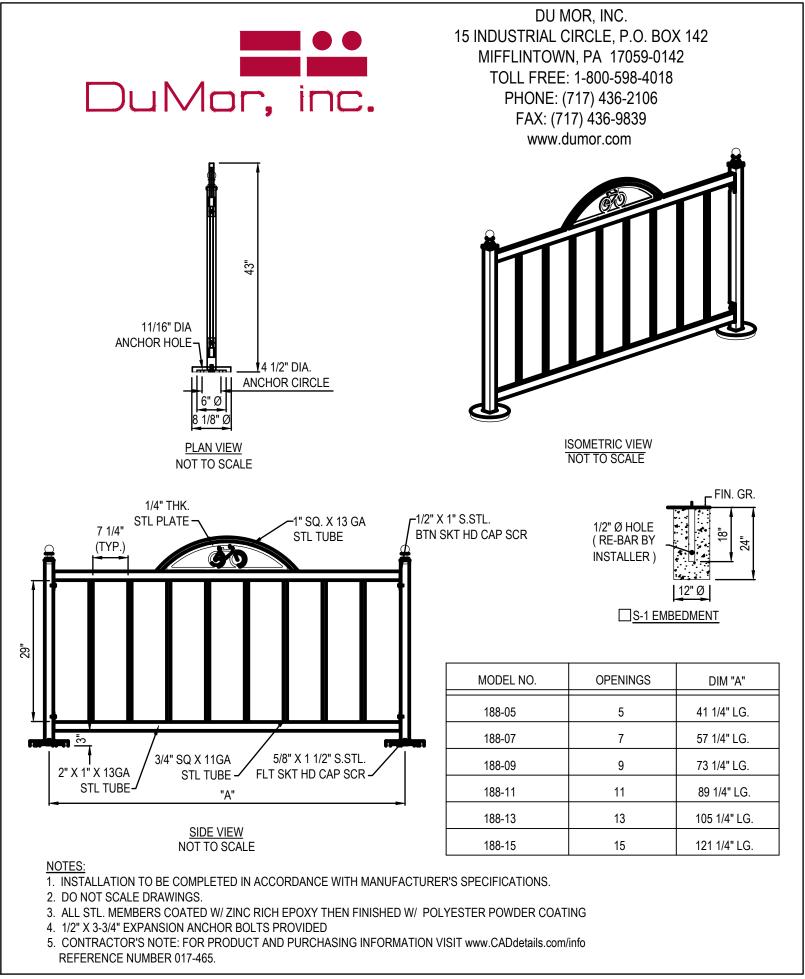
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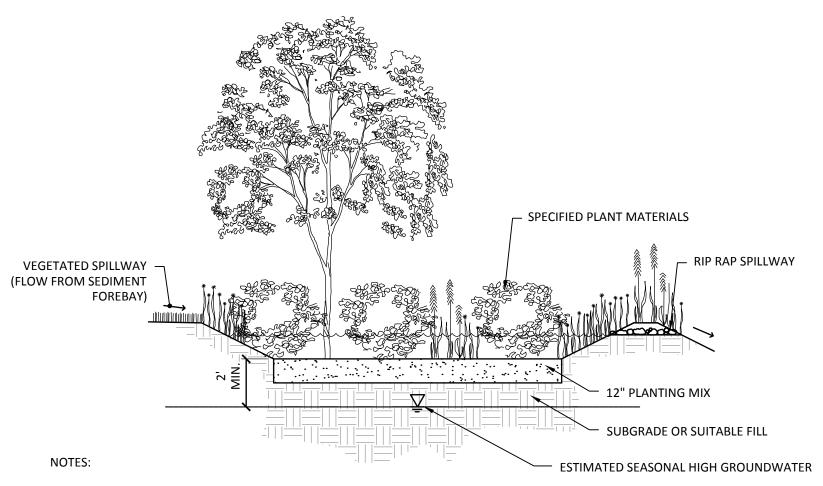









BIKE RACK DETAIL

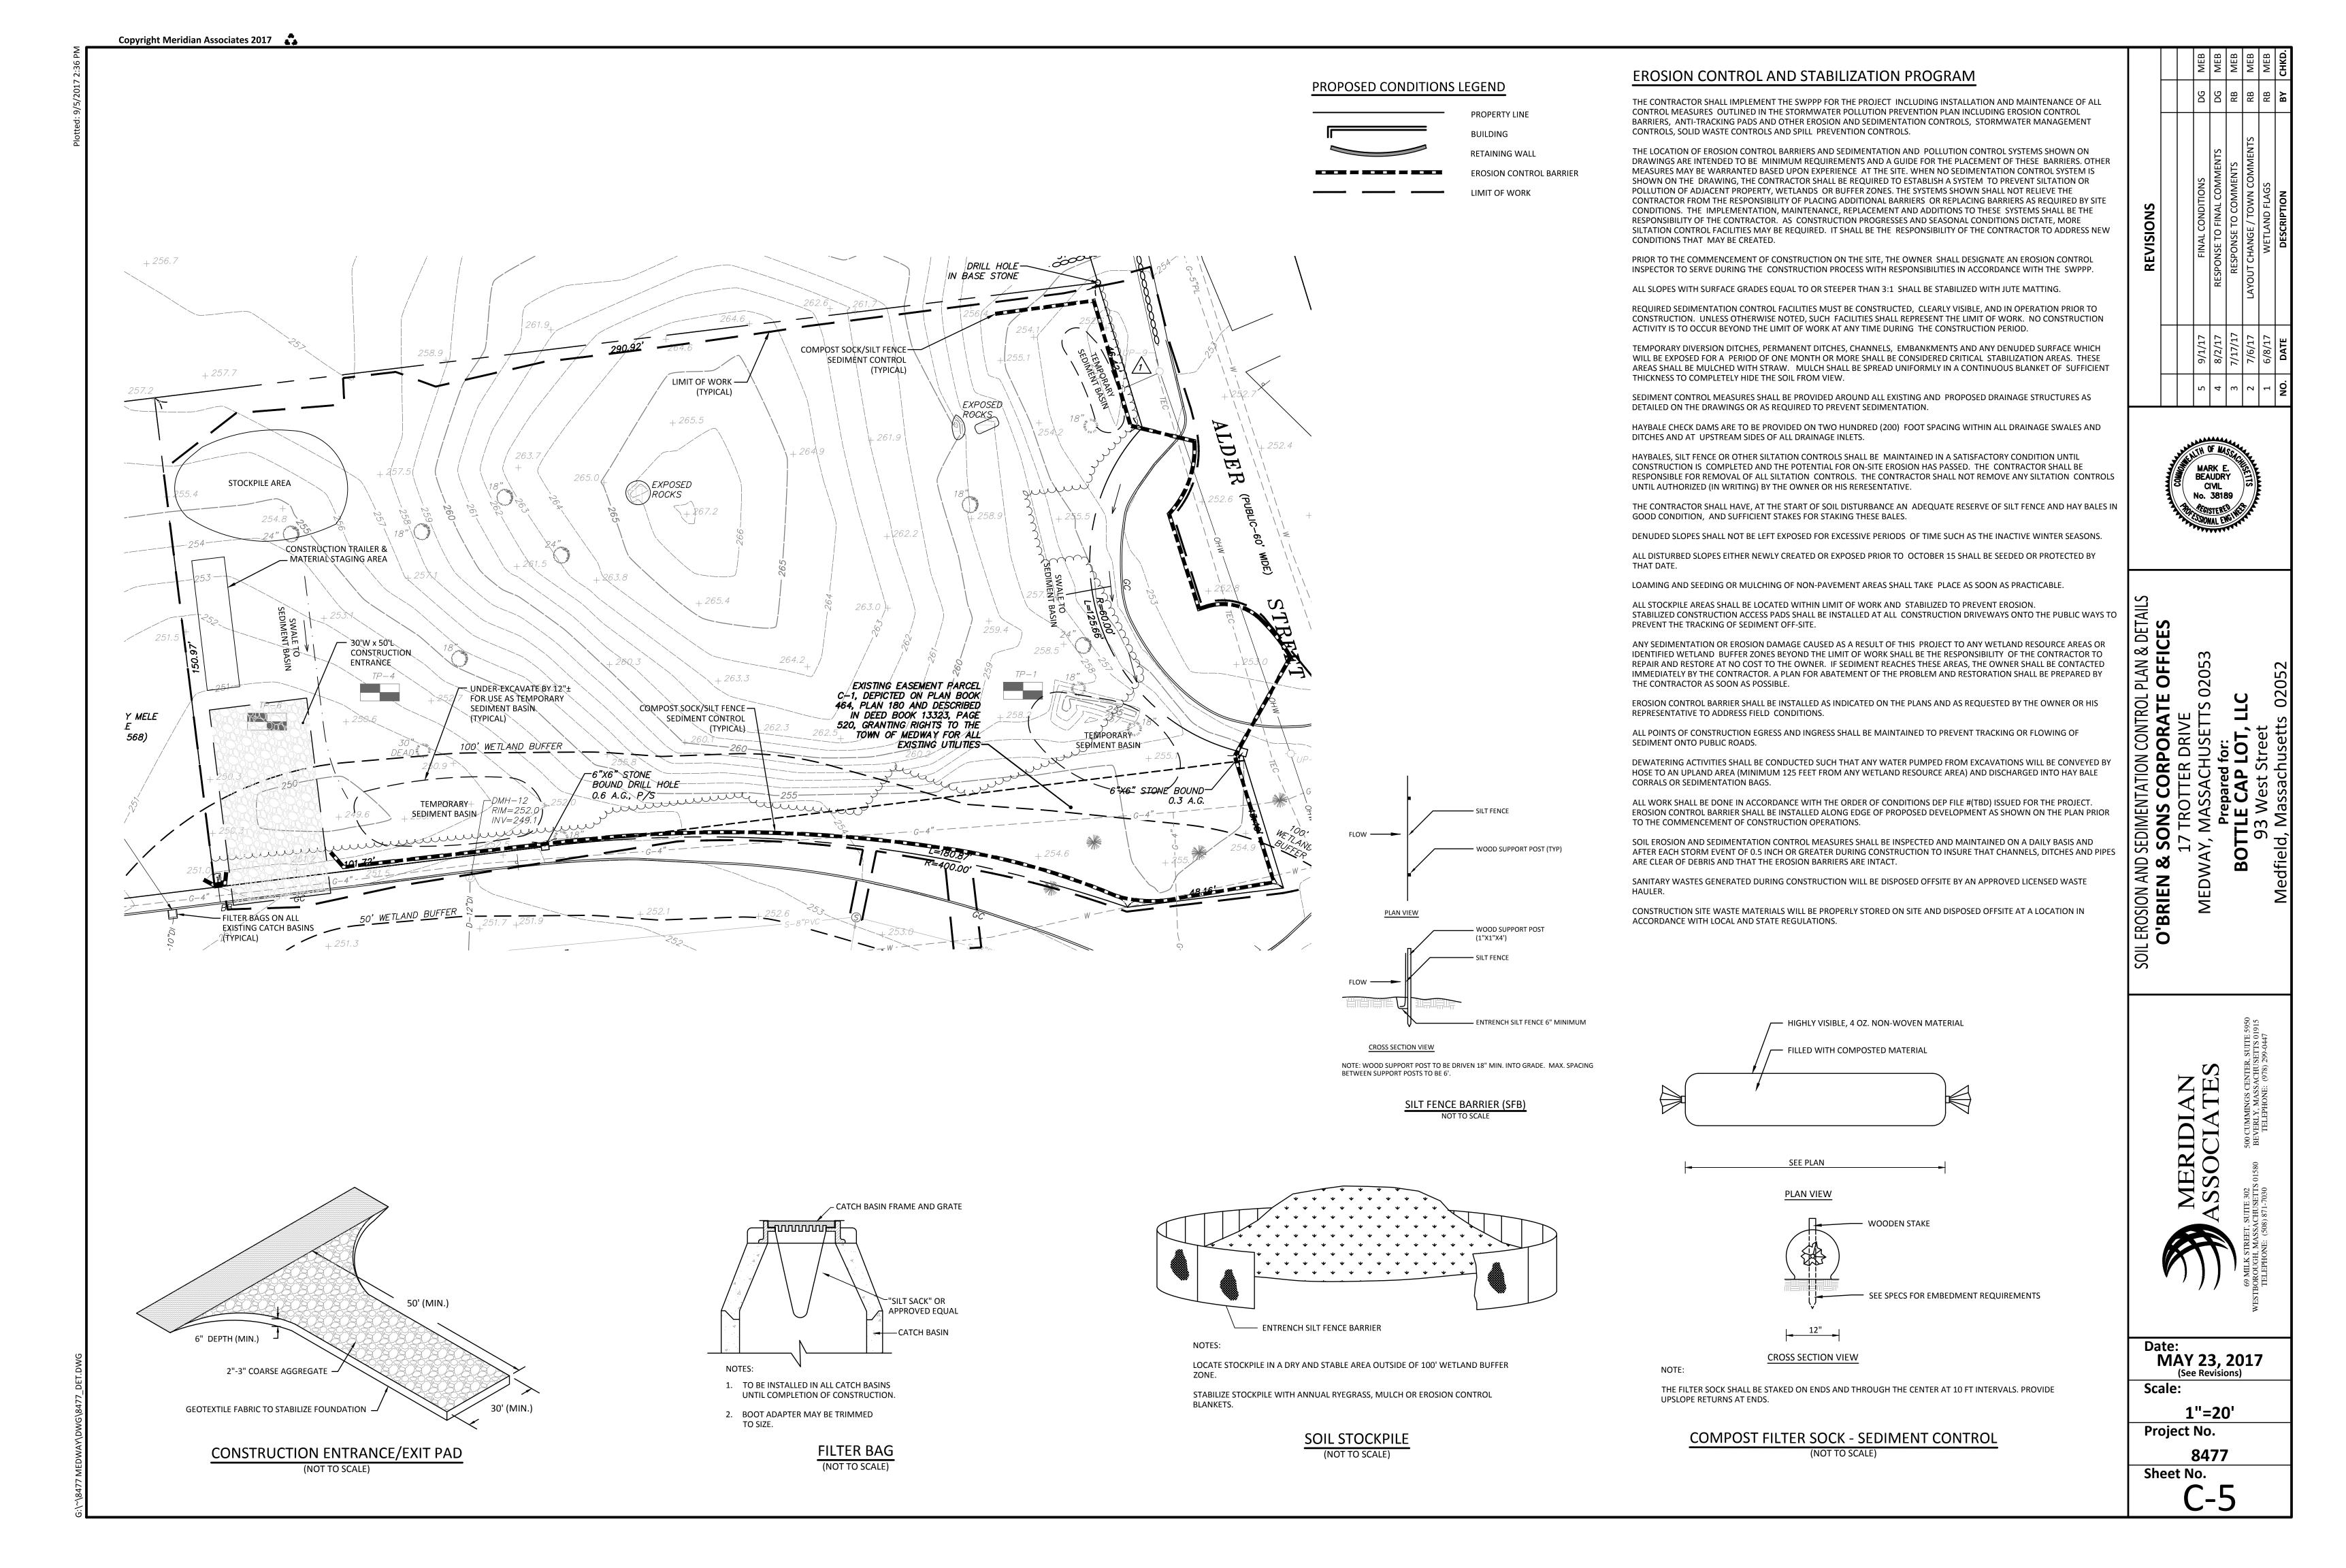

SEE PLANS FOR LOCATIONS AND SIZES OF BIO-RETENTION ELEMENTS AND PLANT MATERIALS.


THE PLANTING MIX SHOULD BE A MIXTURE OF SAND, COMPOST AND SOIL. SPECIFICALLY, 40% SAND, 20-30% TOPSOIL, AND 30-40% COMPOST. THE CLAY CONTENT SHOULD NOT EXCEED 15%. MIX MUST BE UNIFORM, FREE OF STONES, STUMPS, ROOTS OR SIMILAR OBJECTS LARGER THAT 2 INCHES.

SCHEMATIC OF BIO-RETENTION BASIN

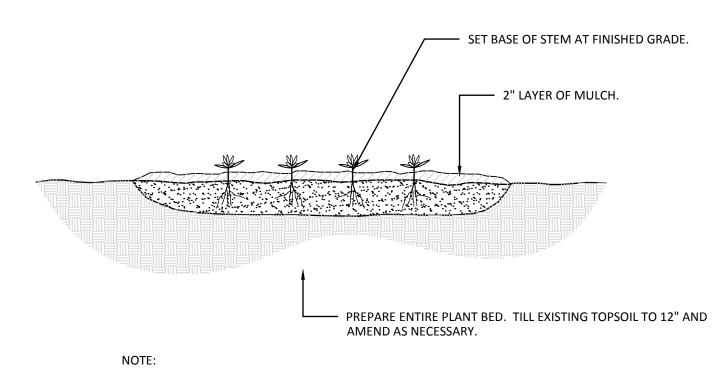

SPACE PLANTS EQUALLY TO PROVIDE CONSISTENT COVER OVER INDICATED PLANTING BED.

GROUNDCOVER PLANTING

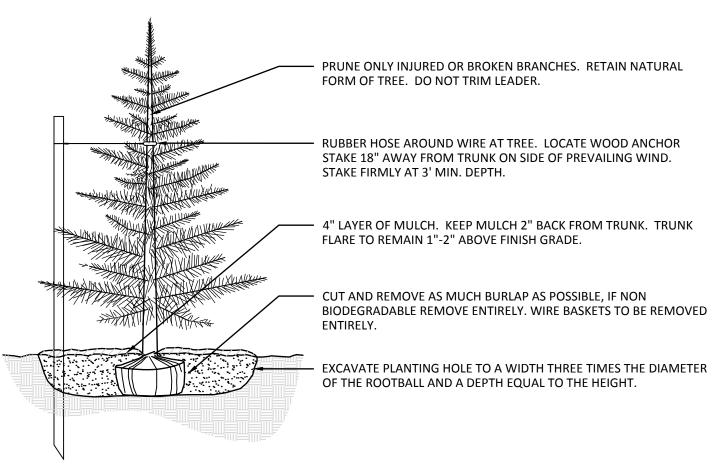


BACKFILL PLANTING HOLE WITH EXISTING SOIL AMENDED AS NECESSARY.


BACKFILL HALF THE SOIL AND WATER TO SETTLE OUT AIR POCKETS, COMPLETE BACKFILLING AND


IF ROOTS ARE CIRCLING THE ROOTBALL EXTERIOR, CUT ROOTS VERTICALLY IN SEVERAL PLACES PRIOR

ONLY STAKE TREES SITUATED ON WINDY SITES OR EXPOSED TO SUBSTANTIAL PEDESTRIAN TRAFFIC.

EVERGREEN TREE PLANTING

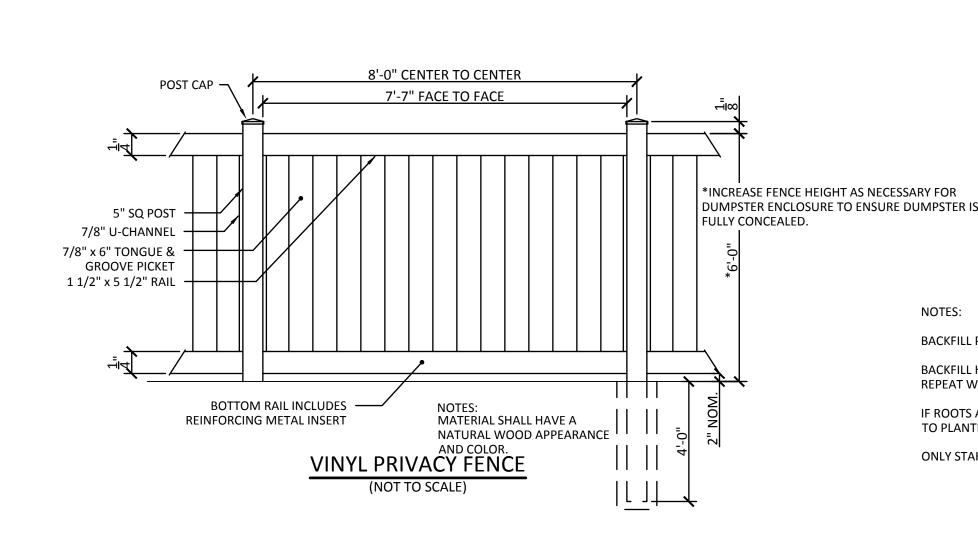

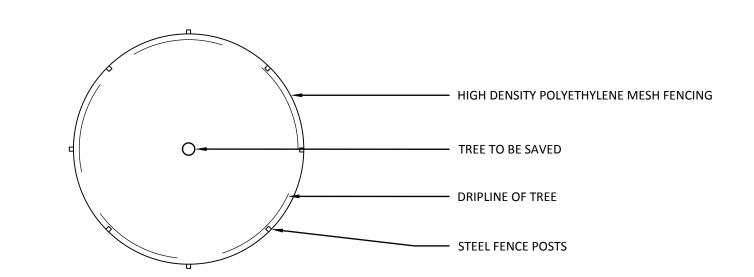

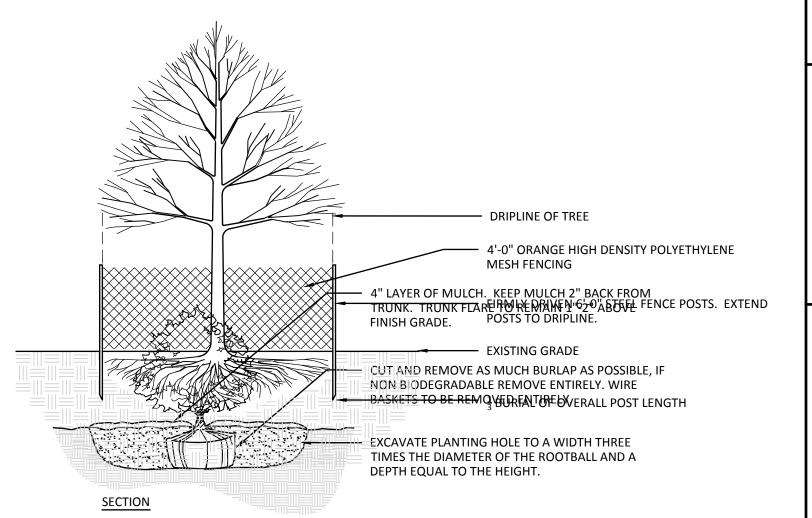


TREE PROTECTION

BACKFILL PLANTING HOLE WITH EXISTING SOIL AMENDED AS NECESTAR SCALE) BACKFILL HALF THE SOIL AND WATER TO SETTLE OUT AIR POCKETS, COMPLETE BACKFILLING AND REPEAT WATERING.

IF ROOTS ARE CIRCLING THE ROOTBALL EXTERIOR, CUT ROOTS VERTICALLY IN SEVERAL PLACES PRIOR TO PLANTING.

SHRUB PLANTING

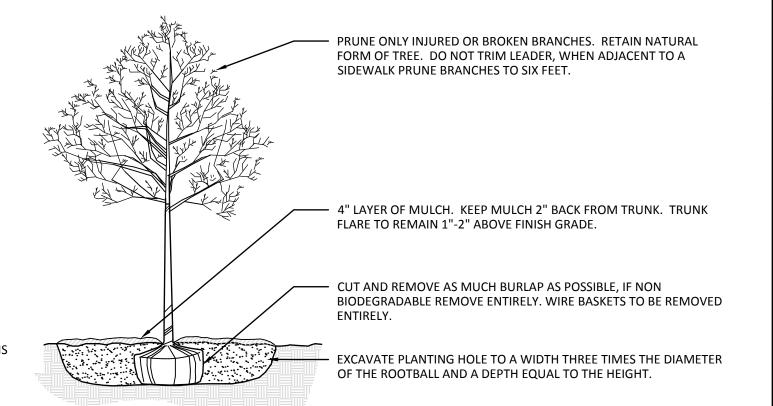

NOTES:

NOTES:

BACKFILL PLANTING HOLE WITH EXISTING SOIL AMENDED AS NECESSARY.

BACKFILL HALF THE SOIL AND WATER TO SETTLE OUT AIR POCKETS, COMPLETE BACKFILLING AND REPEAT WATERING.

IF ROOTS ARE CIRCLING THE ROOTBALL EXTERIOR, CUT ROOTS VERTICALLY IN SEVERAL PLACES PRIOR

ONLY STAKE TREES SITUATED ON WINDY SITES OR EXPOSED TO SUBSTANTIAL PEDESTRIAN TRAFFIC.

TREE PLANTING (NOT TO SCALE)



BRIEN


MERIDIAN ASSOCIATES


MAY 23, 2017 (See Revisions) Scale:

1"=20'

Project No. 8477

Sheet No.

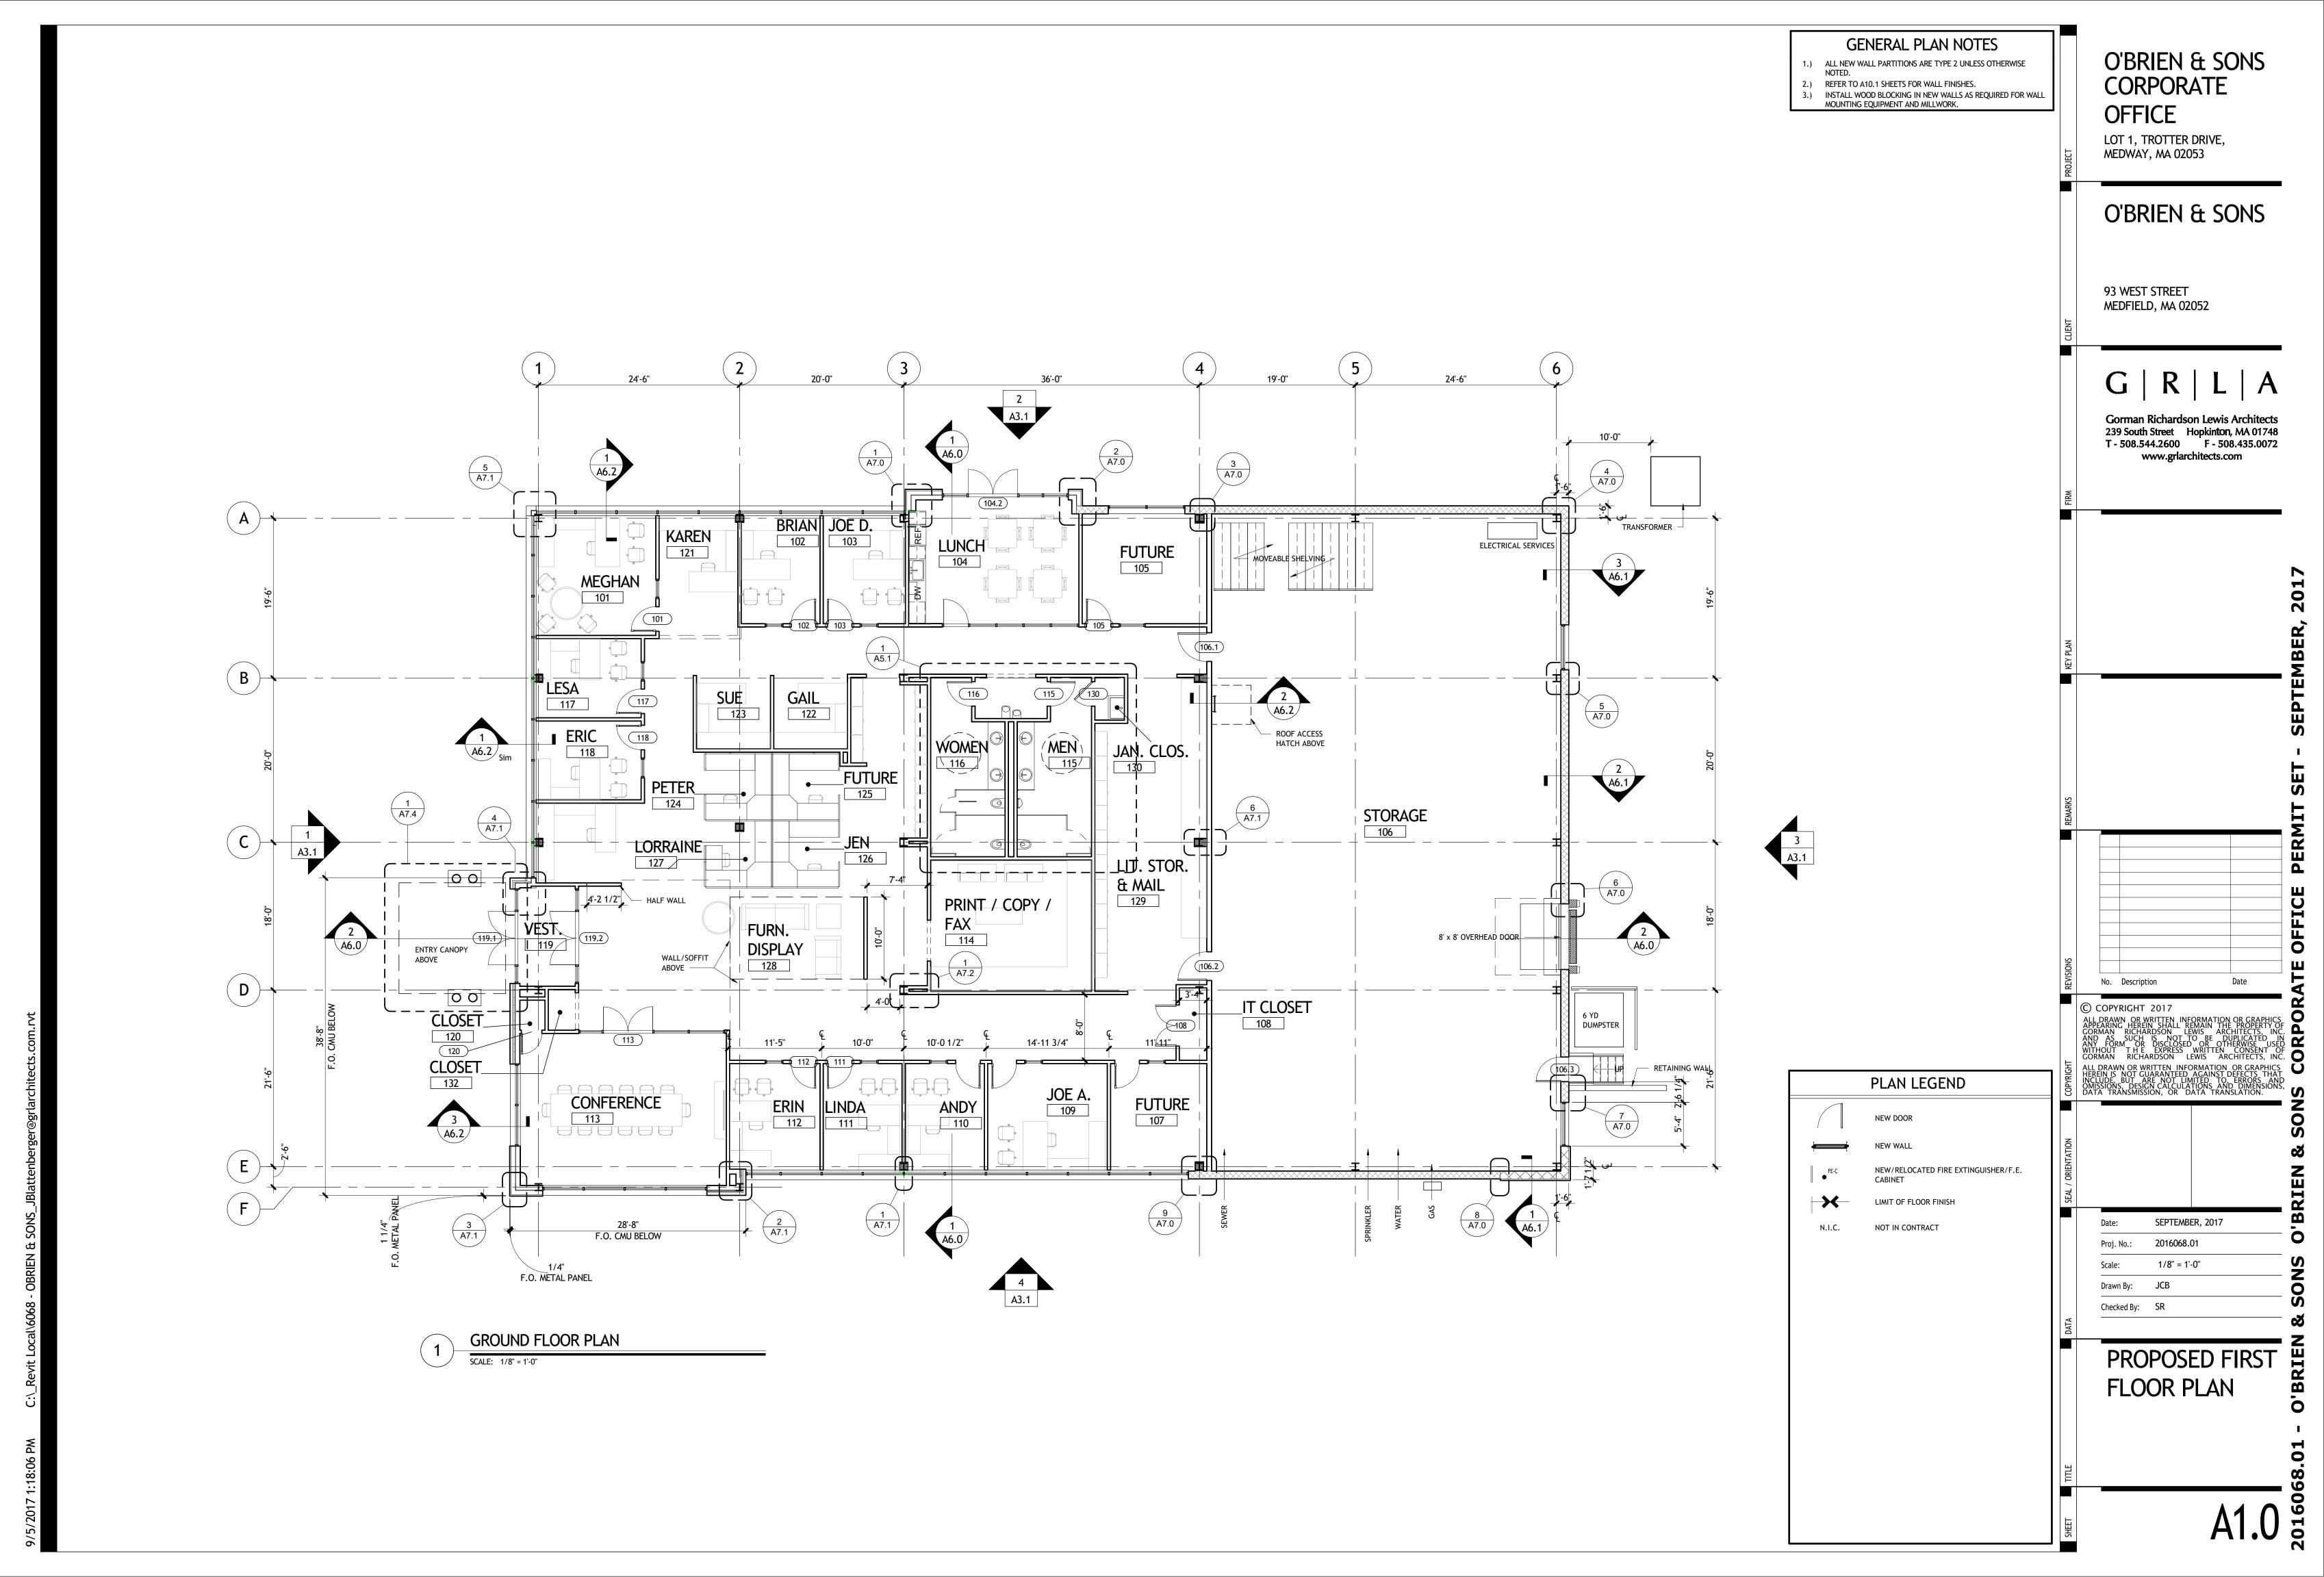

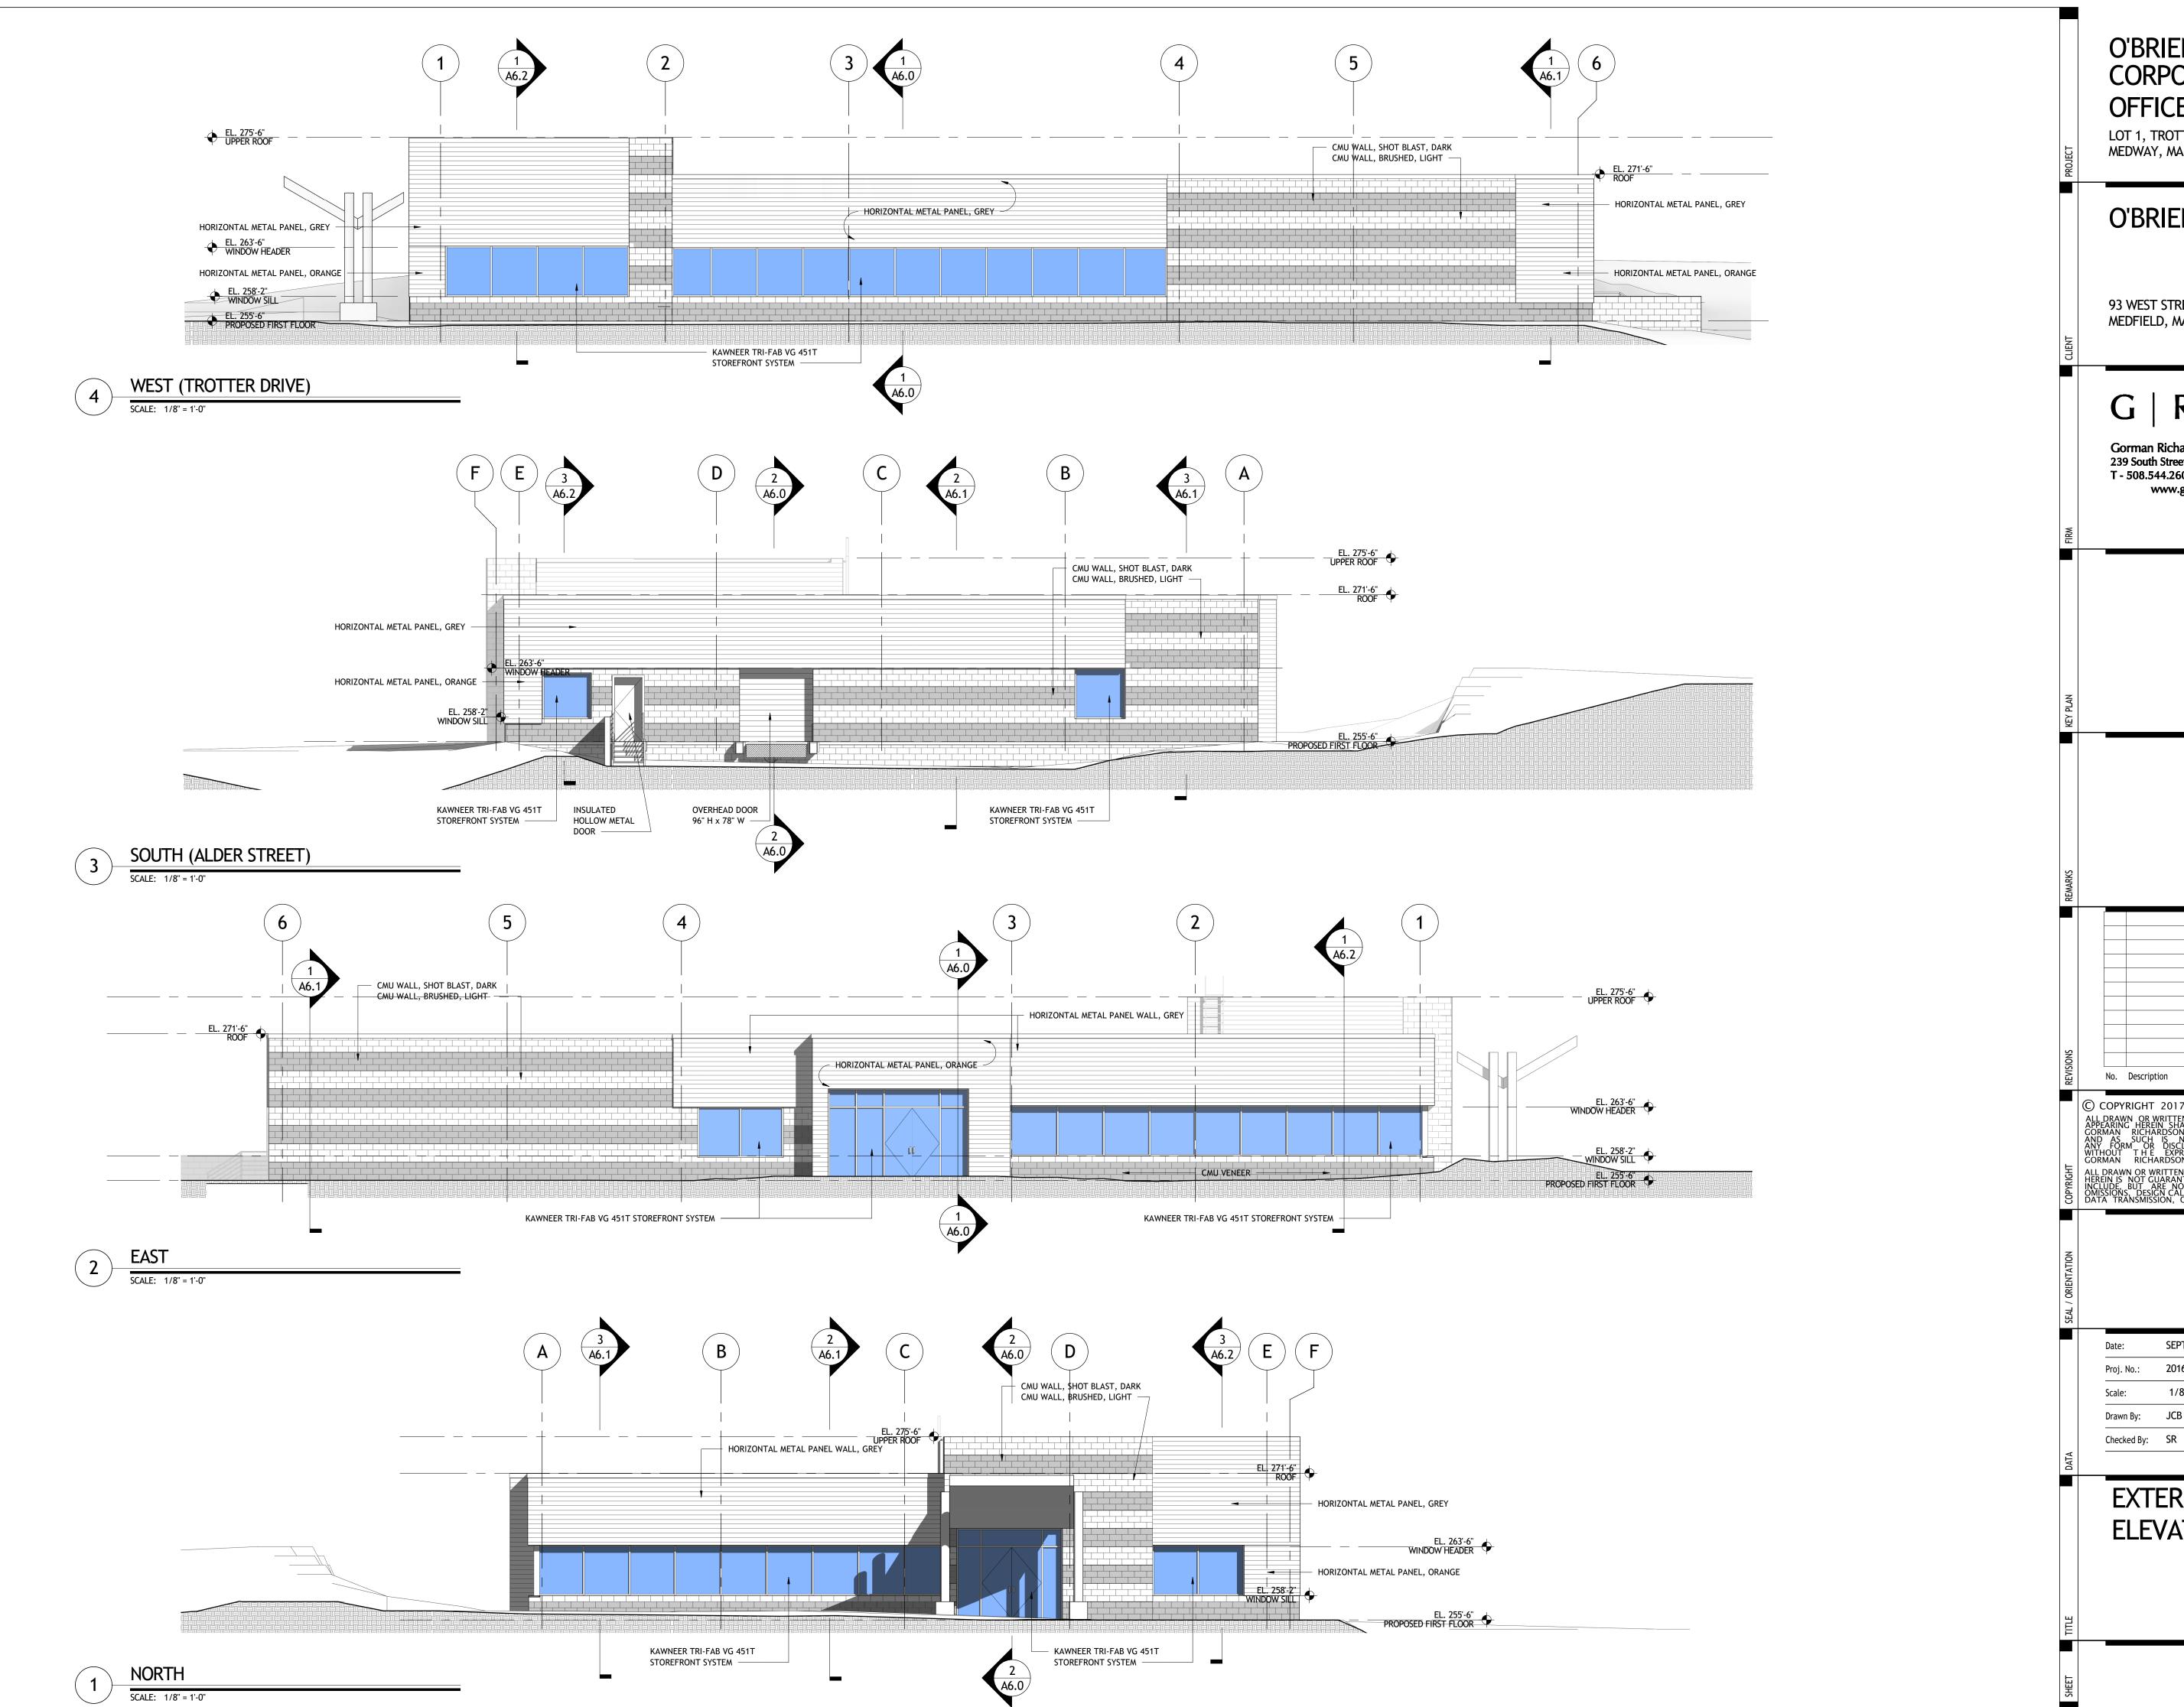

O'BRIEN & SONS CORPORATE OFFICE

LOT 1, TROTTER DRIVE, MEDWAY, MA 02053

O'BRIEN & SONS

93 WEST STREET MEDFIELD, MA 02052


Gorman Richardson Lewis Architects 239 South Street Hopkinton, MA 01748 T - 508.544.2600 F - 508.435.0072 www.grlarchitects.com


No. Description © COPYRIGHT 2017

SEPTEMBER, 2017

SEPTEMBER, 2017 2016068.01 Proj. No.: 1/8" = 1'-0" Drawn By: JCB

EXTERIOR ELEVATIONS

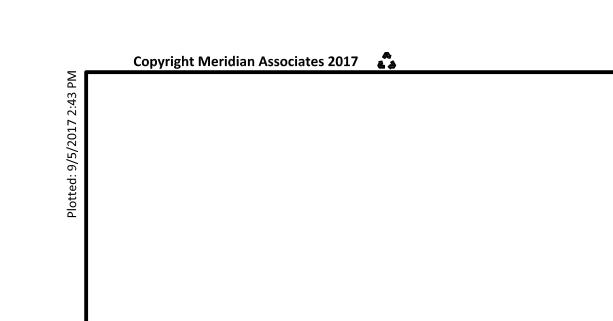

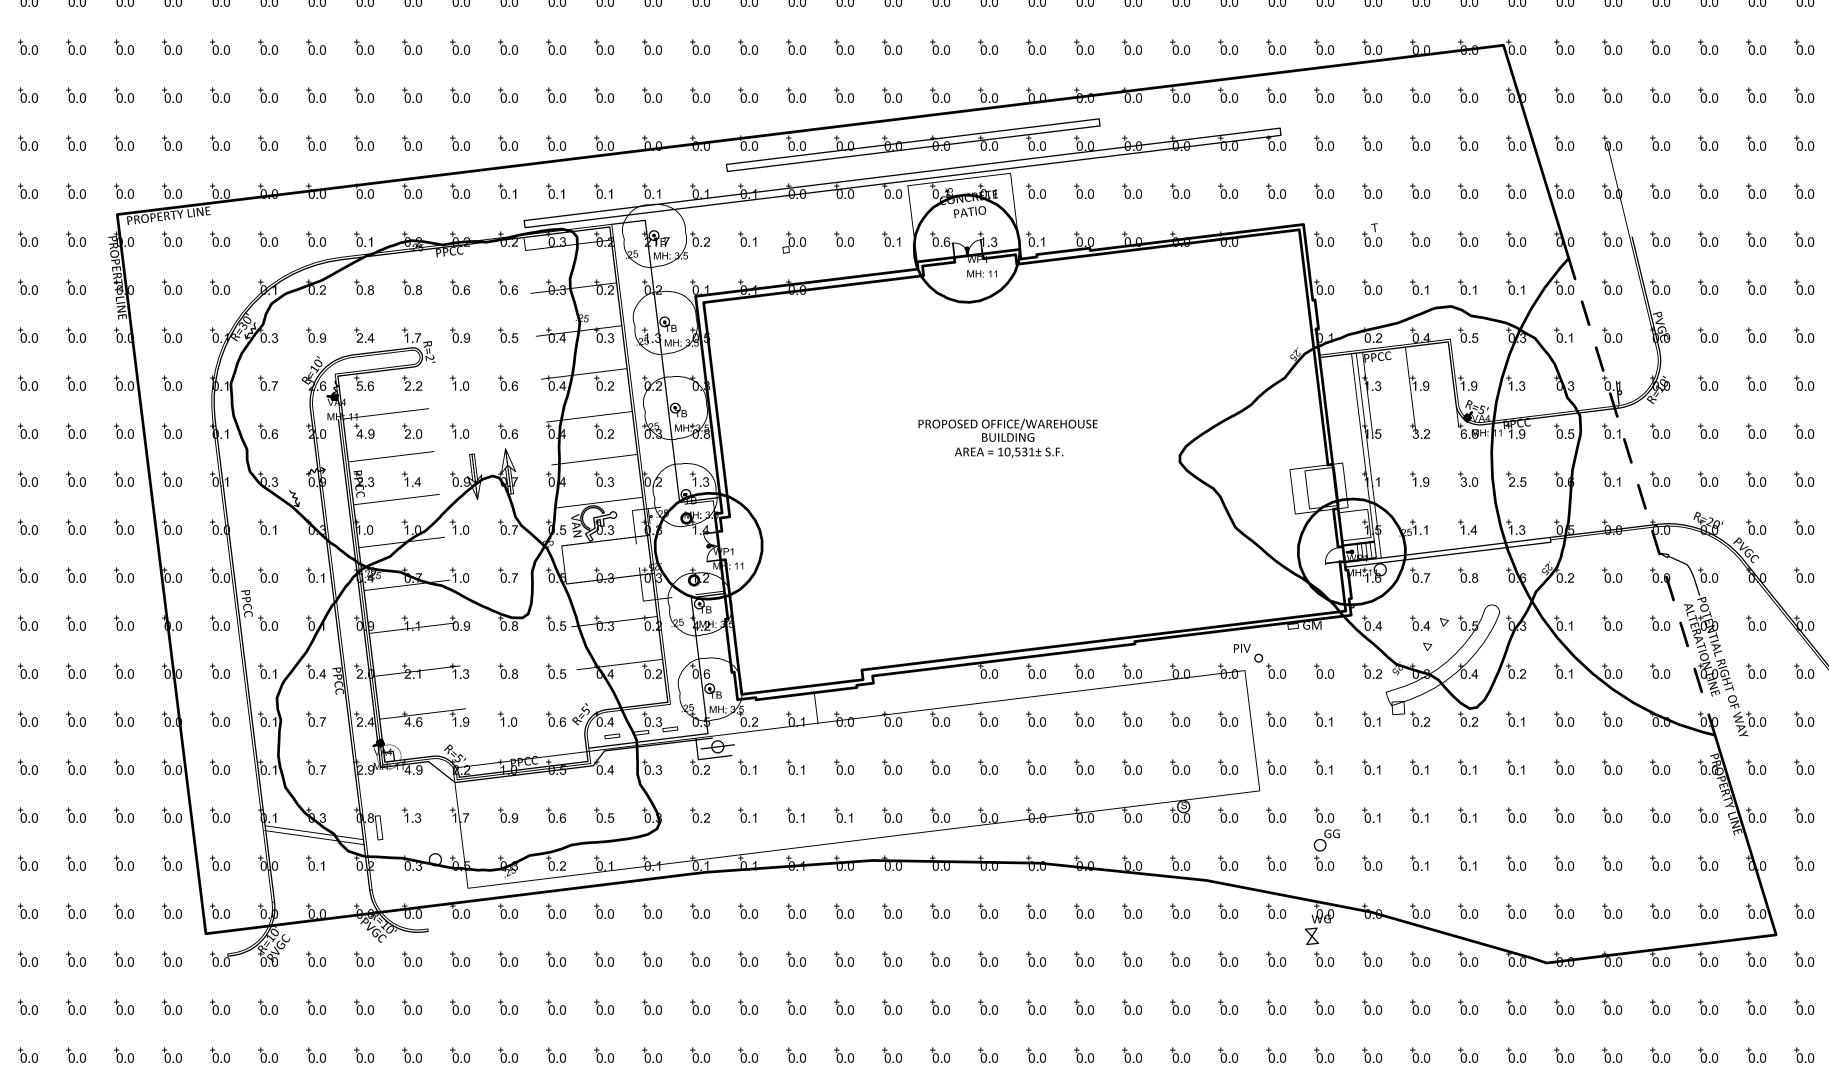


Outdoor Luminai	Outdoor Luminaire Schedule										
Symbol	Qty	Label	Description	Arm	Lum. Lumens	LLF	Filename				
—	3	WP1	22 380	1	465	0.800	22380.ies				
\odot	6	TB	7000BTUR8304240CHUNVS	0	1995	0.800	102171228CHI-074 GB 700O				
中	3	VA4	VA1-L83-730-T4-F-S-xxx-xxx	1.5	6773	0.800	VA1-L83-730-T4-F-x-xxx-x				

LumNo	Label	X	Y	Z	Orient	Tilt
1	VA4	-10398.375	10231.375	11	24.997	10
2	TB	-10328.375	10243.25	3.5	7	0
3	TB	-10330.5	10261	3.5	7	0
4	WP1	-10195.625	10271.75	11	4.434	0
5	WP1	-10327.625	10273.125	11	186.116	0
6	TB	-10333.625	10283.75	3.5	7	0
7	VA4	-10169.625	10300.875	11	229.635	10
8	TB	-10335.625	10301.875	3.5	7	0
9	VA4	-10408	10304.25	11	352.626	10
10	TB	-10337.75	10319.625	3.5	7	0
11	WP1	-10274.75	10334	11	92.553	0
12	TB	-10340	10337.75	3.5	7	0

	Calculation Summary											
	Label	CalcType	Units	Avg	Max	Min	Avg/Min	Max/Min				
	CalcPts_1	Illuminance	Fc	0.22	21.7	0.0	N.A.	N.A.				



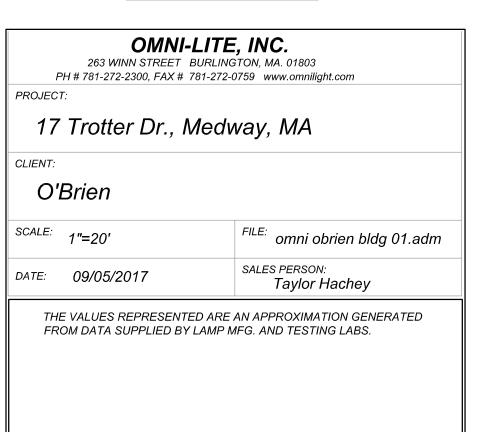

LIGHTING PLAN

O'BRIEN & SONS CORPORATE OFFIC

17 TROTTER DRIVE

MEDWAY, MASSACHUSETTS 02053

MERIDIAN ASSOCIATIES

Date:
MAY 23, 2017
(See Revisions)
Scale:

1"=20' Project No.

8477 Sheet No. L-1

SCALE: 1" = 20'
20' 10' 0 20' 40' 60'

VAY\DWG\8477_SITE.DWG

CalcPts_1