SITE DEVELOPMENT PLANS

HARMONY VILLAGE

MULTYFAMILY HOUSING DEVELOPMENT 218-220 MAIN STREET (MAP 57, PARCEL 44) MEDWAY, MASSACHUSETTS 02053

ZONING DISTRICT: AR-II
MULTIFAMILY HOUSING OVERLAY DISTRICT

REVISED SEPTEMBER 8, 2020

OWNER

Linda Resner & Elliot Edwards 218 Main Street Medway, MA 02053

APPLICANT

HARMONY ESTATES, LLC 5 EXCHANGE STREET MILFORD, MASSACHUSETTS 01757

CIVIL ENGINEERING, SURVEYING & LANDSCAPE ARCHITECTURE



69 MILK STREET, SUITE 208 WESTBOROUGH, MASSACHUSETTS 015 500 CUMMINGS CENTER, SUITE 5950 BEVERLY, MASSACHUSETTS 01915


ARCHITECTURE

PACIFIC-VISIONS STUDIO LLC

38 Thompson Ave.

Bristol, RI

T - 774.633.1272

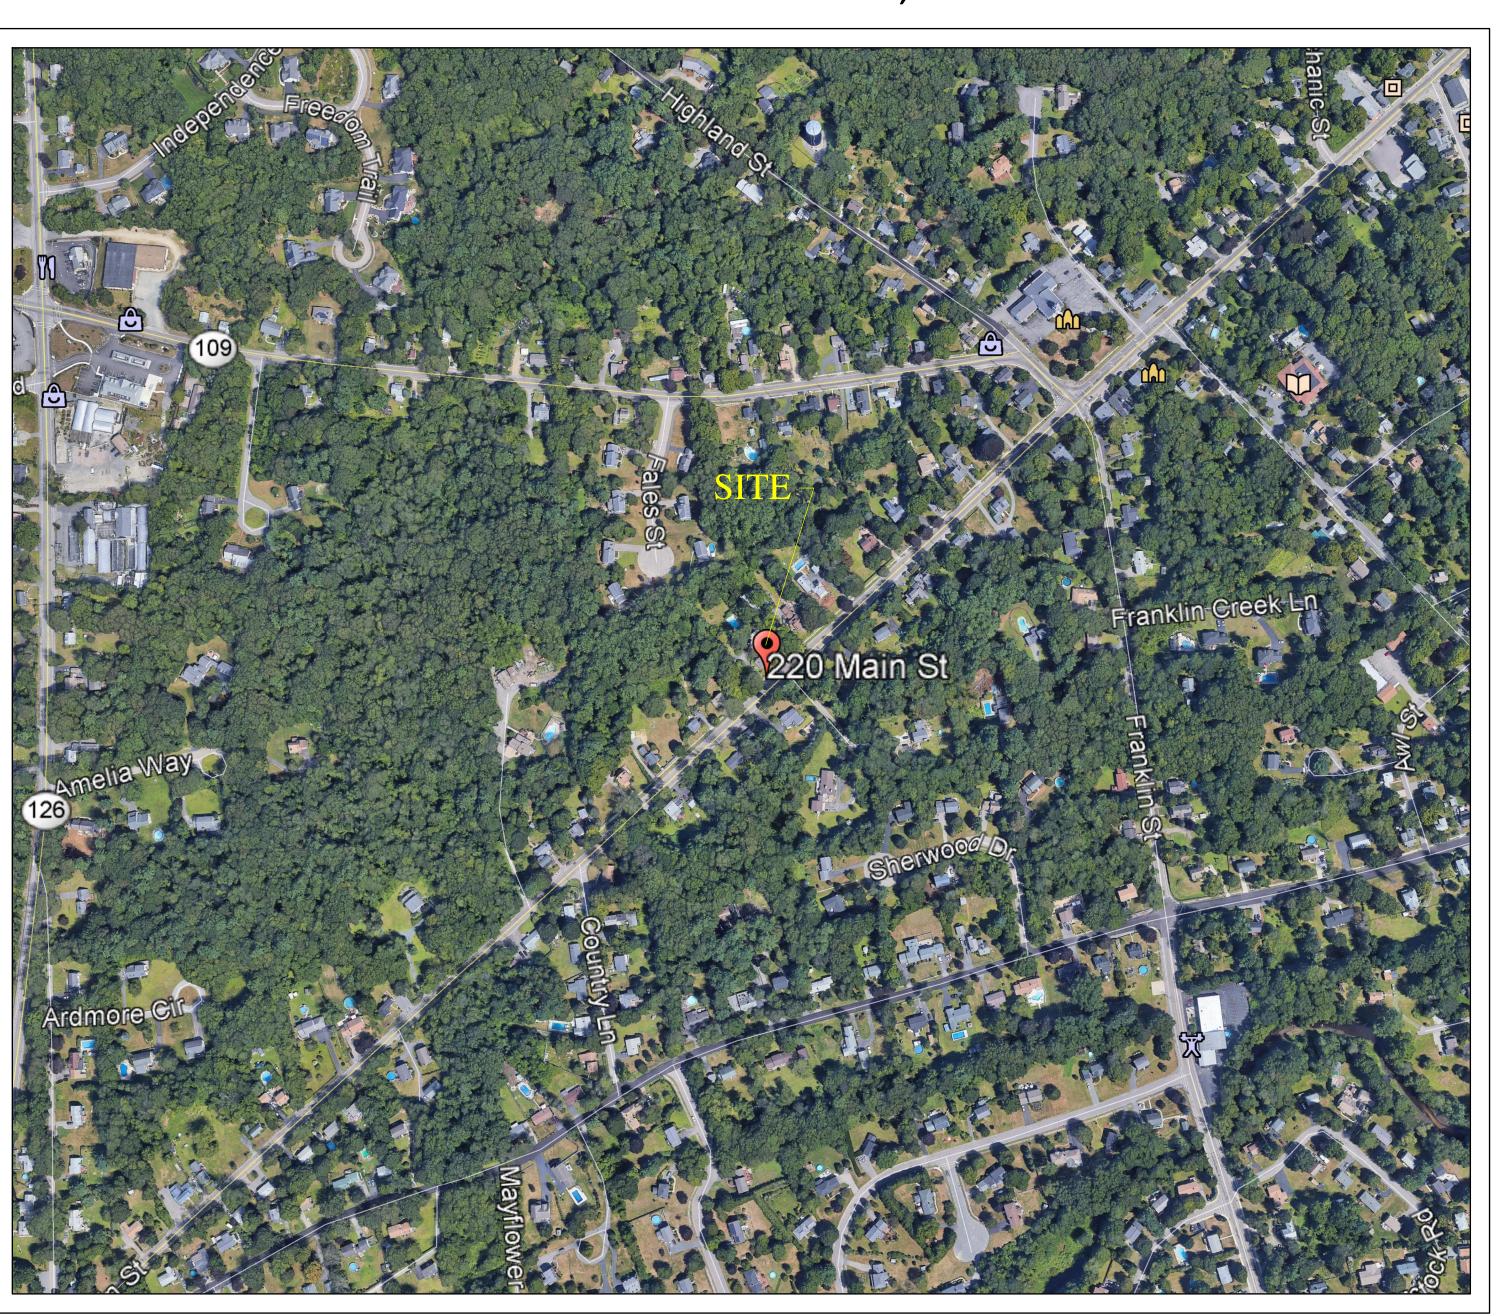

LOCUS MAP SCALE: 1' = 250'

DRAWING INDEX:

- C-1 COVER SHEET/LOCUS MAP
- C-2 EXISTING CONDITIONS PLAN
 - -3 LAYOUT AND MATERIALS PLAN
- C-4 GRADING, DRAINAGE & UTILITIES PLAN
- C-5 LANDSCAPE PLAN
- C-6 EROSION & SEDIMENT CONTROL PLAN
- C-7 SITE DETAILS
- C-8 SITE DETAILS


REQUESTED WAIVERS:


SITE PLAN RULES AND REGULATIONS


- SECTION 207-9 (PEDESTRIAN ACCESS AND SIDEWALKS) NO SIDEWALKS PROPOSED.
- SECTION 207-11.A.4 (VERTICAL GRANITE CURBING AT ENTRANCE ROUNDINGS) CAPE COD BERM PROPOSED.
- SECTION 207-11.B.2 (VERTICAL GRANITE CURBING ALONG DRIVEWAY) CAPE CARD BERM PROPOSED.
- SECTION 207-11.B.3 (DRIVE AISLE TO BE 24 FEET WIDE) 20 FOOT WIDE DRIVE AISLE PROPOSED.


	APPROVED BY THE TOWN OF MEDWAY PLANNING & ECONOMIC DEVELOPMENT BOAF
HEREBY CERTIFY THAT NOTICE OF ROVAL OF THIS PLAN BY THE MEDWAY LANNING & ECONOMIC DEVELOPMENT PARD WAS RECEIVED AND RECORDED THIS OFFICE AND THAT NO NOTICE OF APPEAL WAS FILED IN 20 DAYS FOLLOWING SAID RECEIPT AND RECORDING.	
IN CLERK MEDWAY, MA. DATE	BOARD MEMBER DATE

i Locαtion: Gi\~\8521 MEDWAY\DWG\8521 SITE.

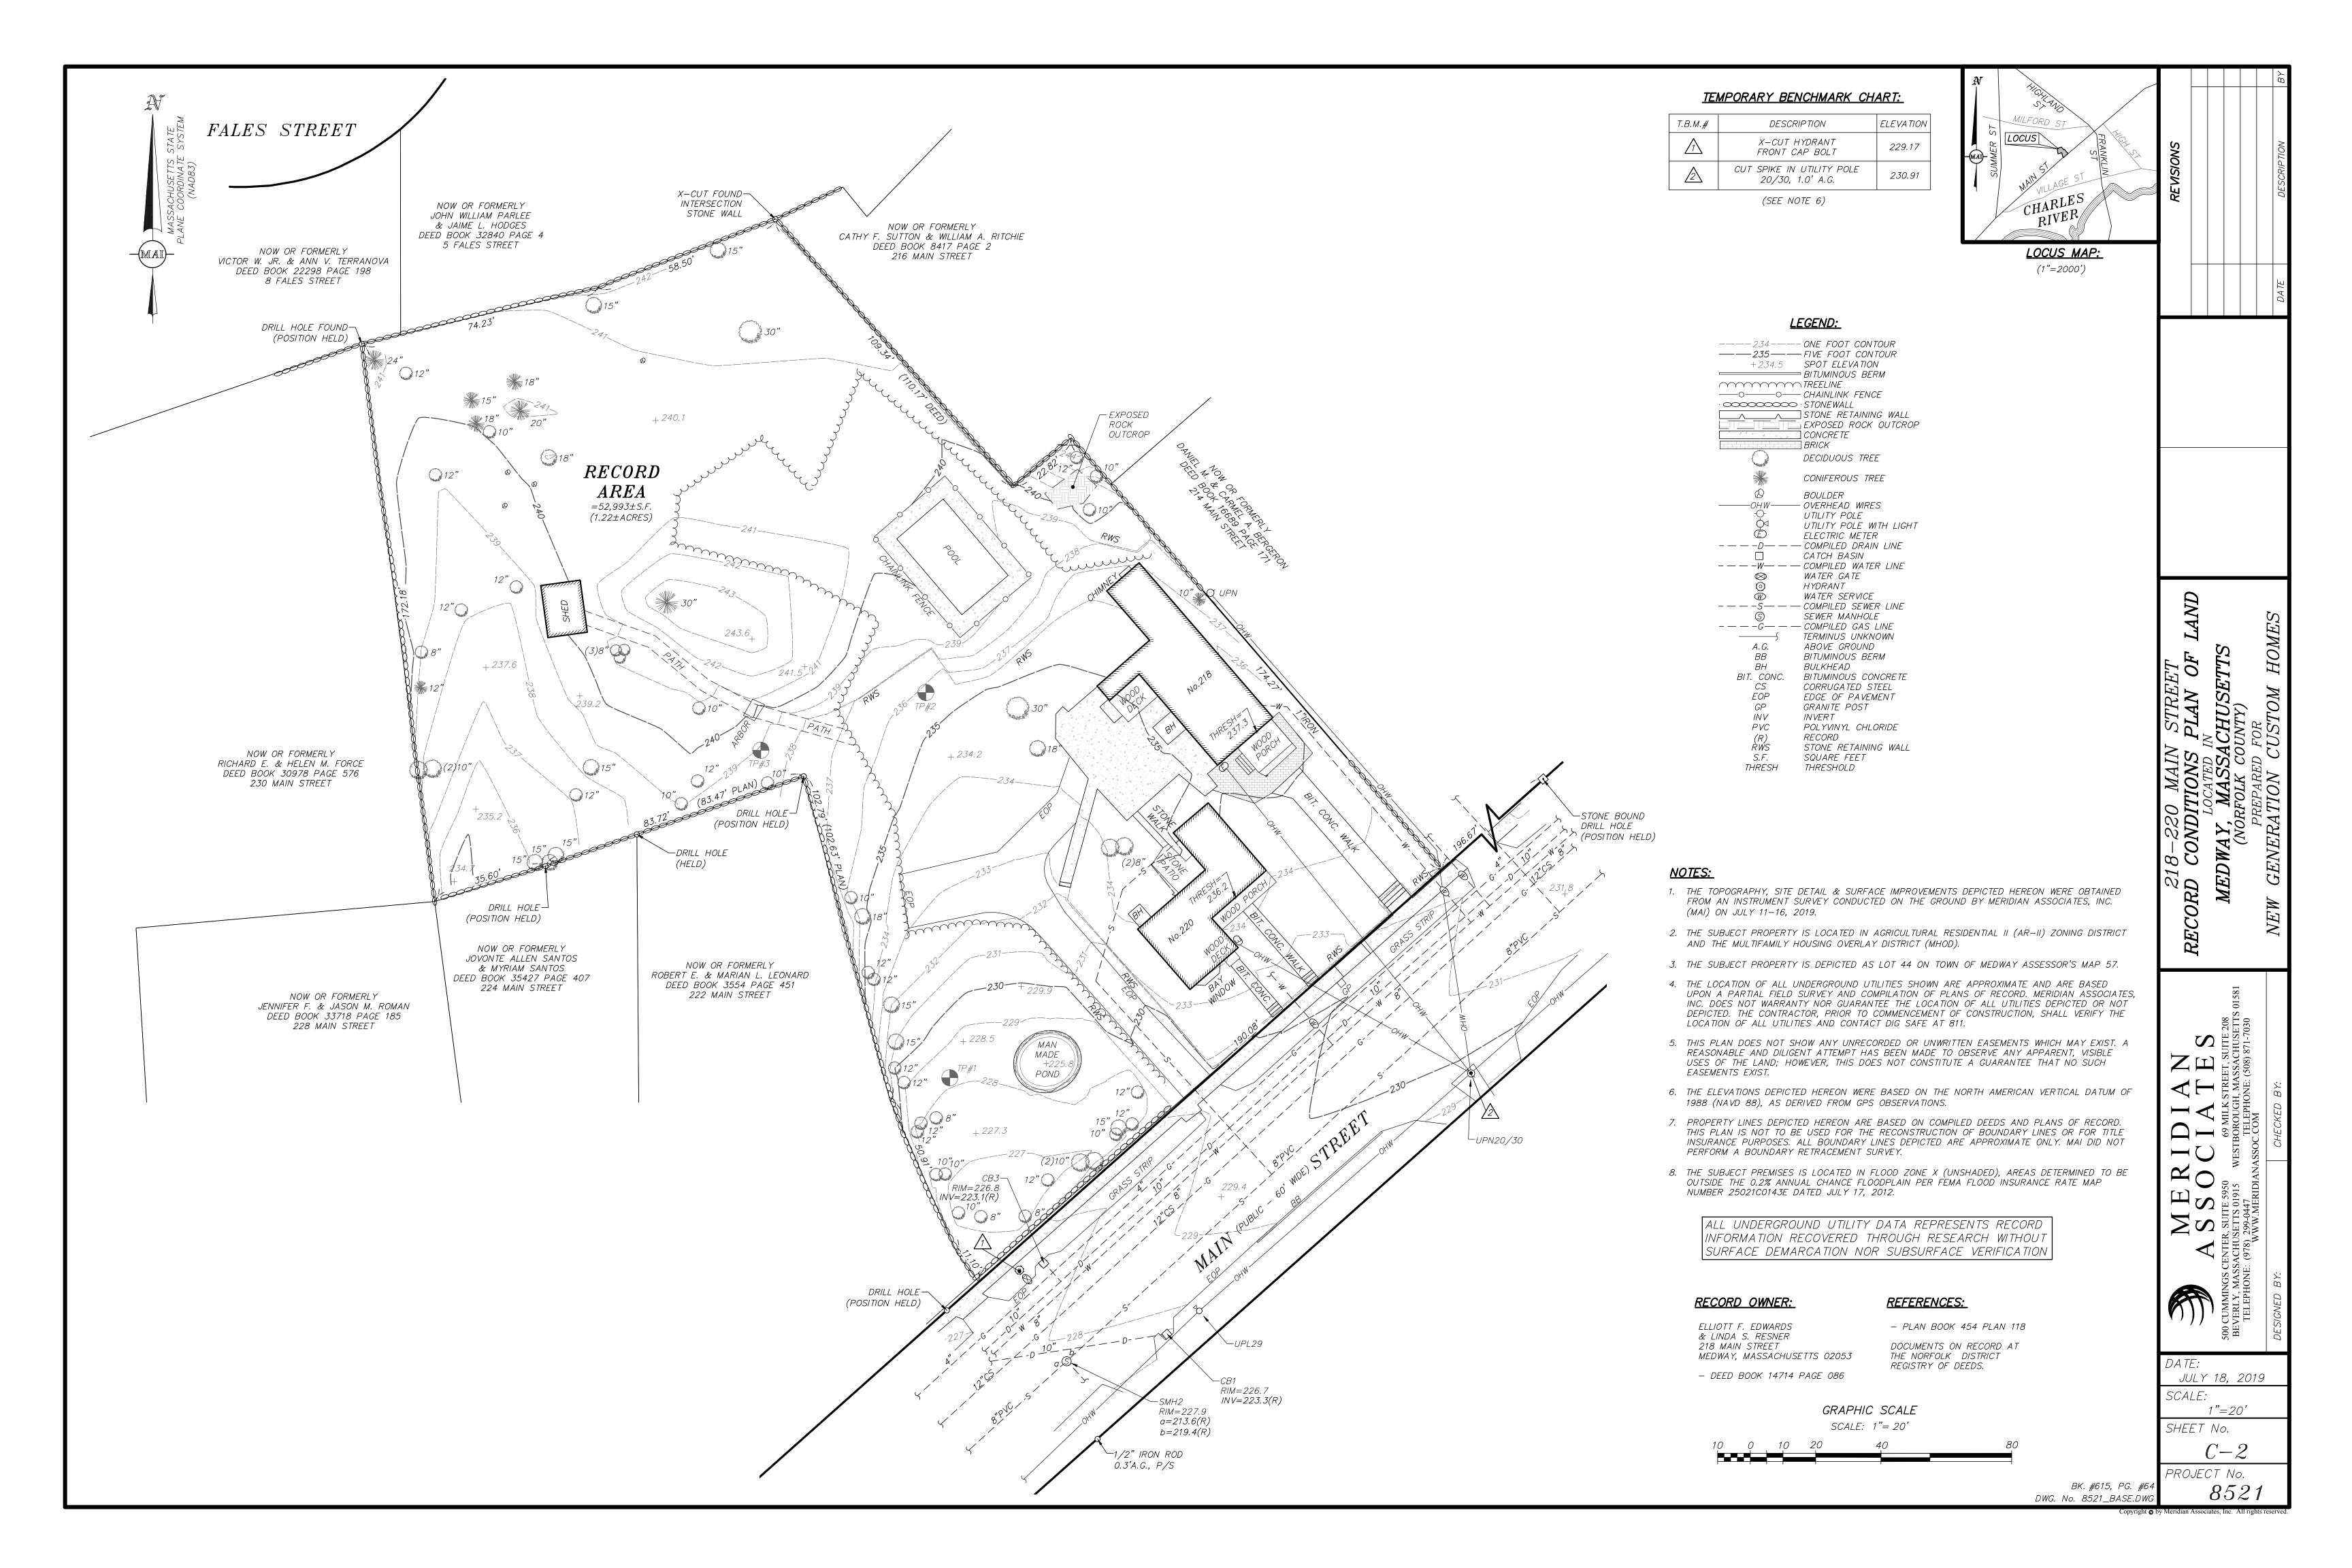

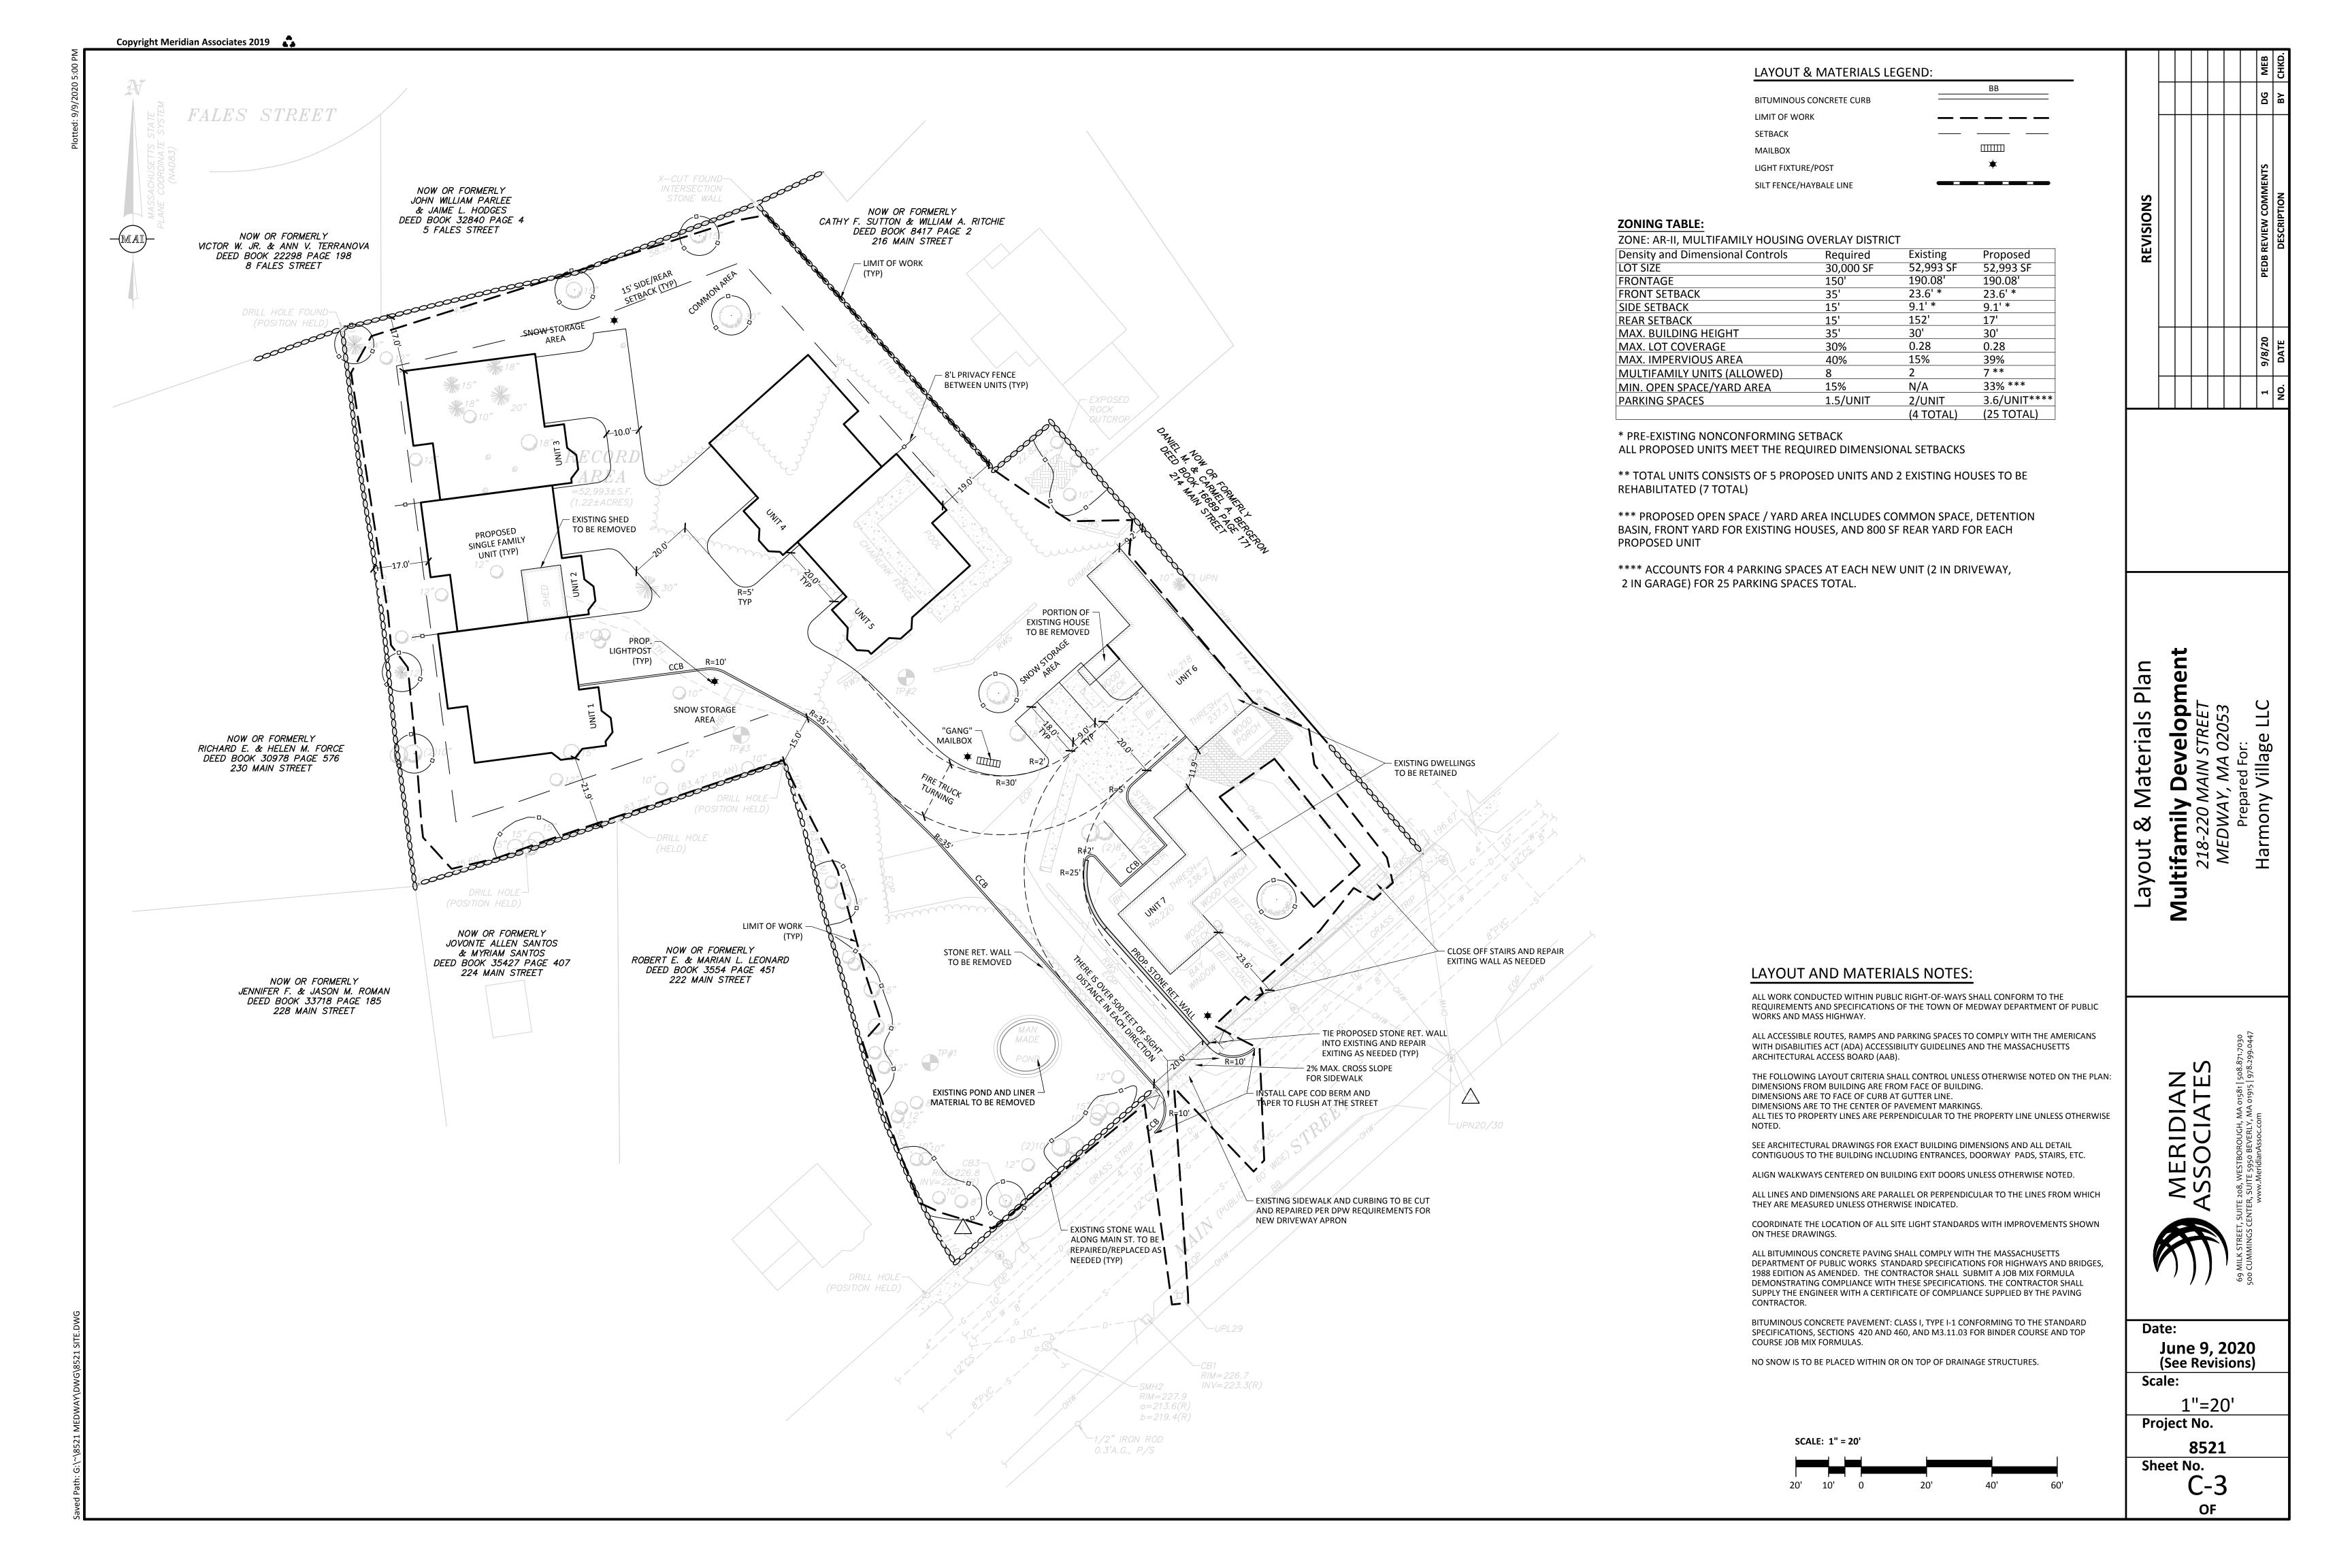

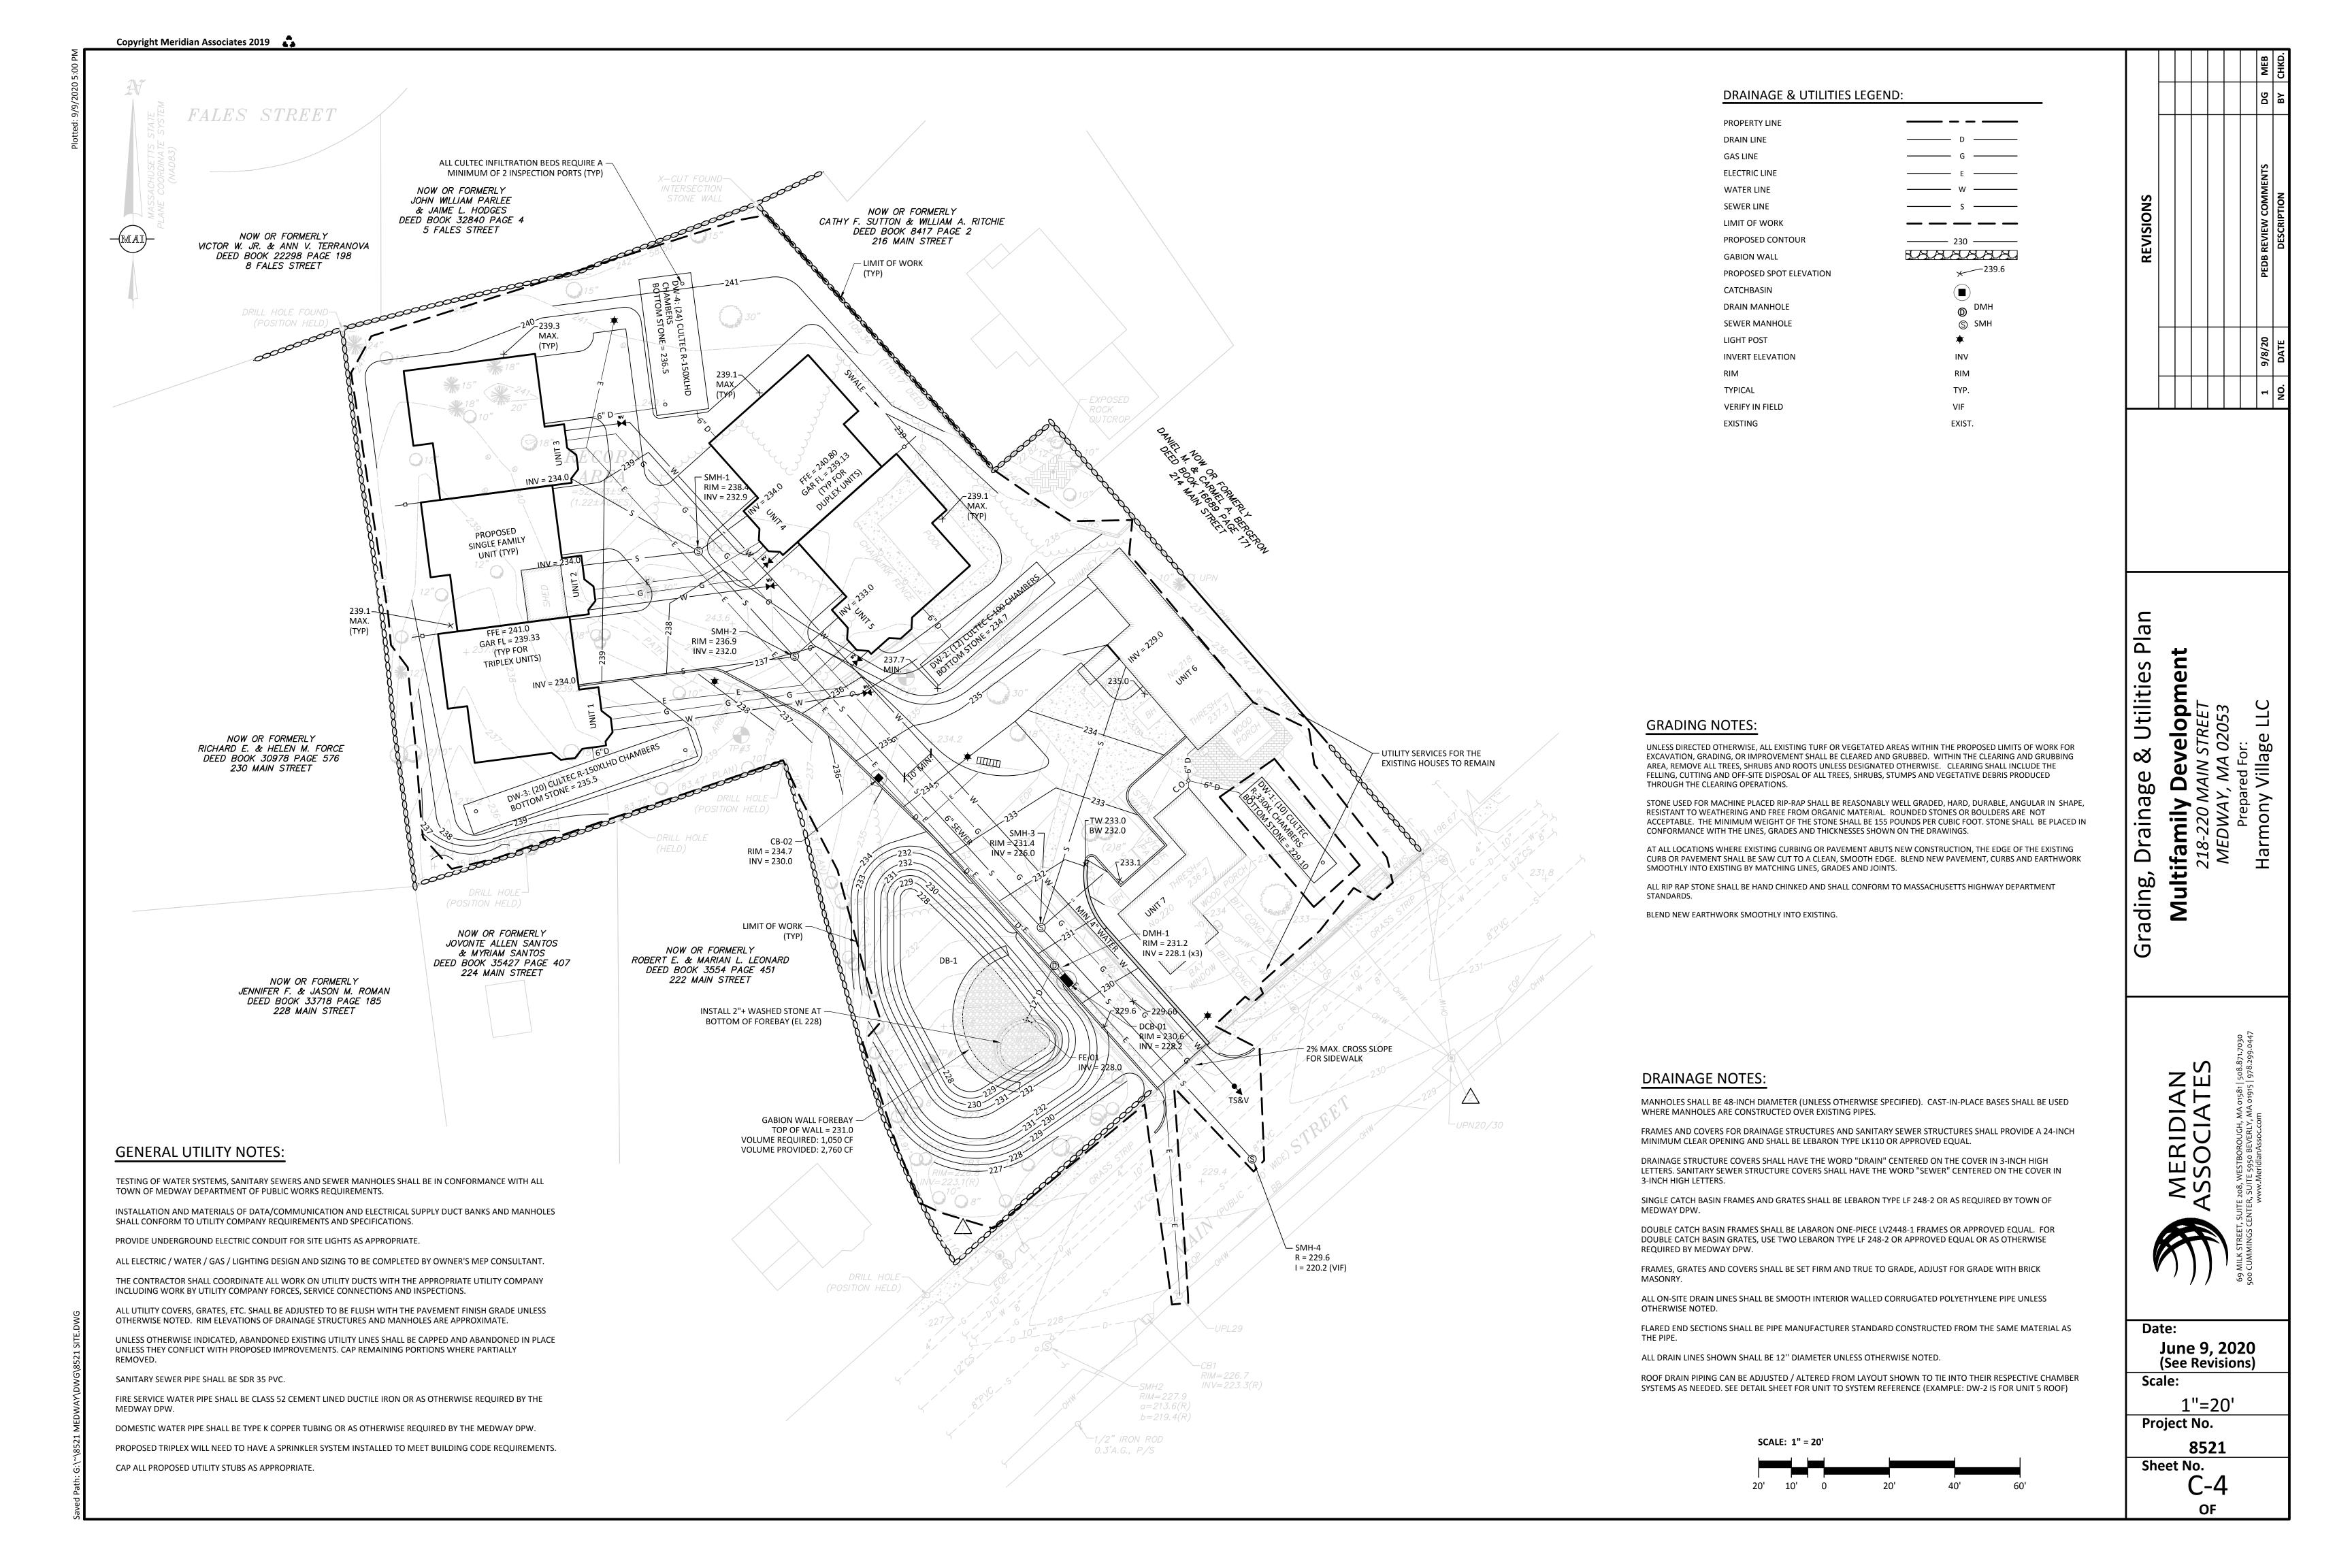

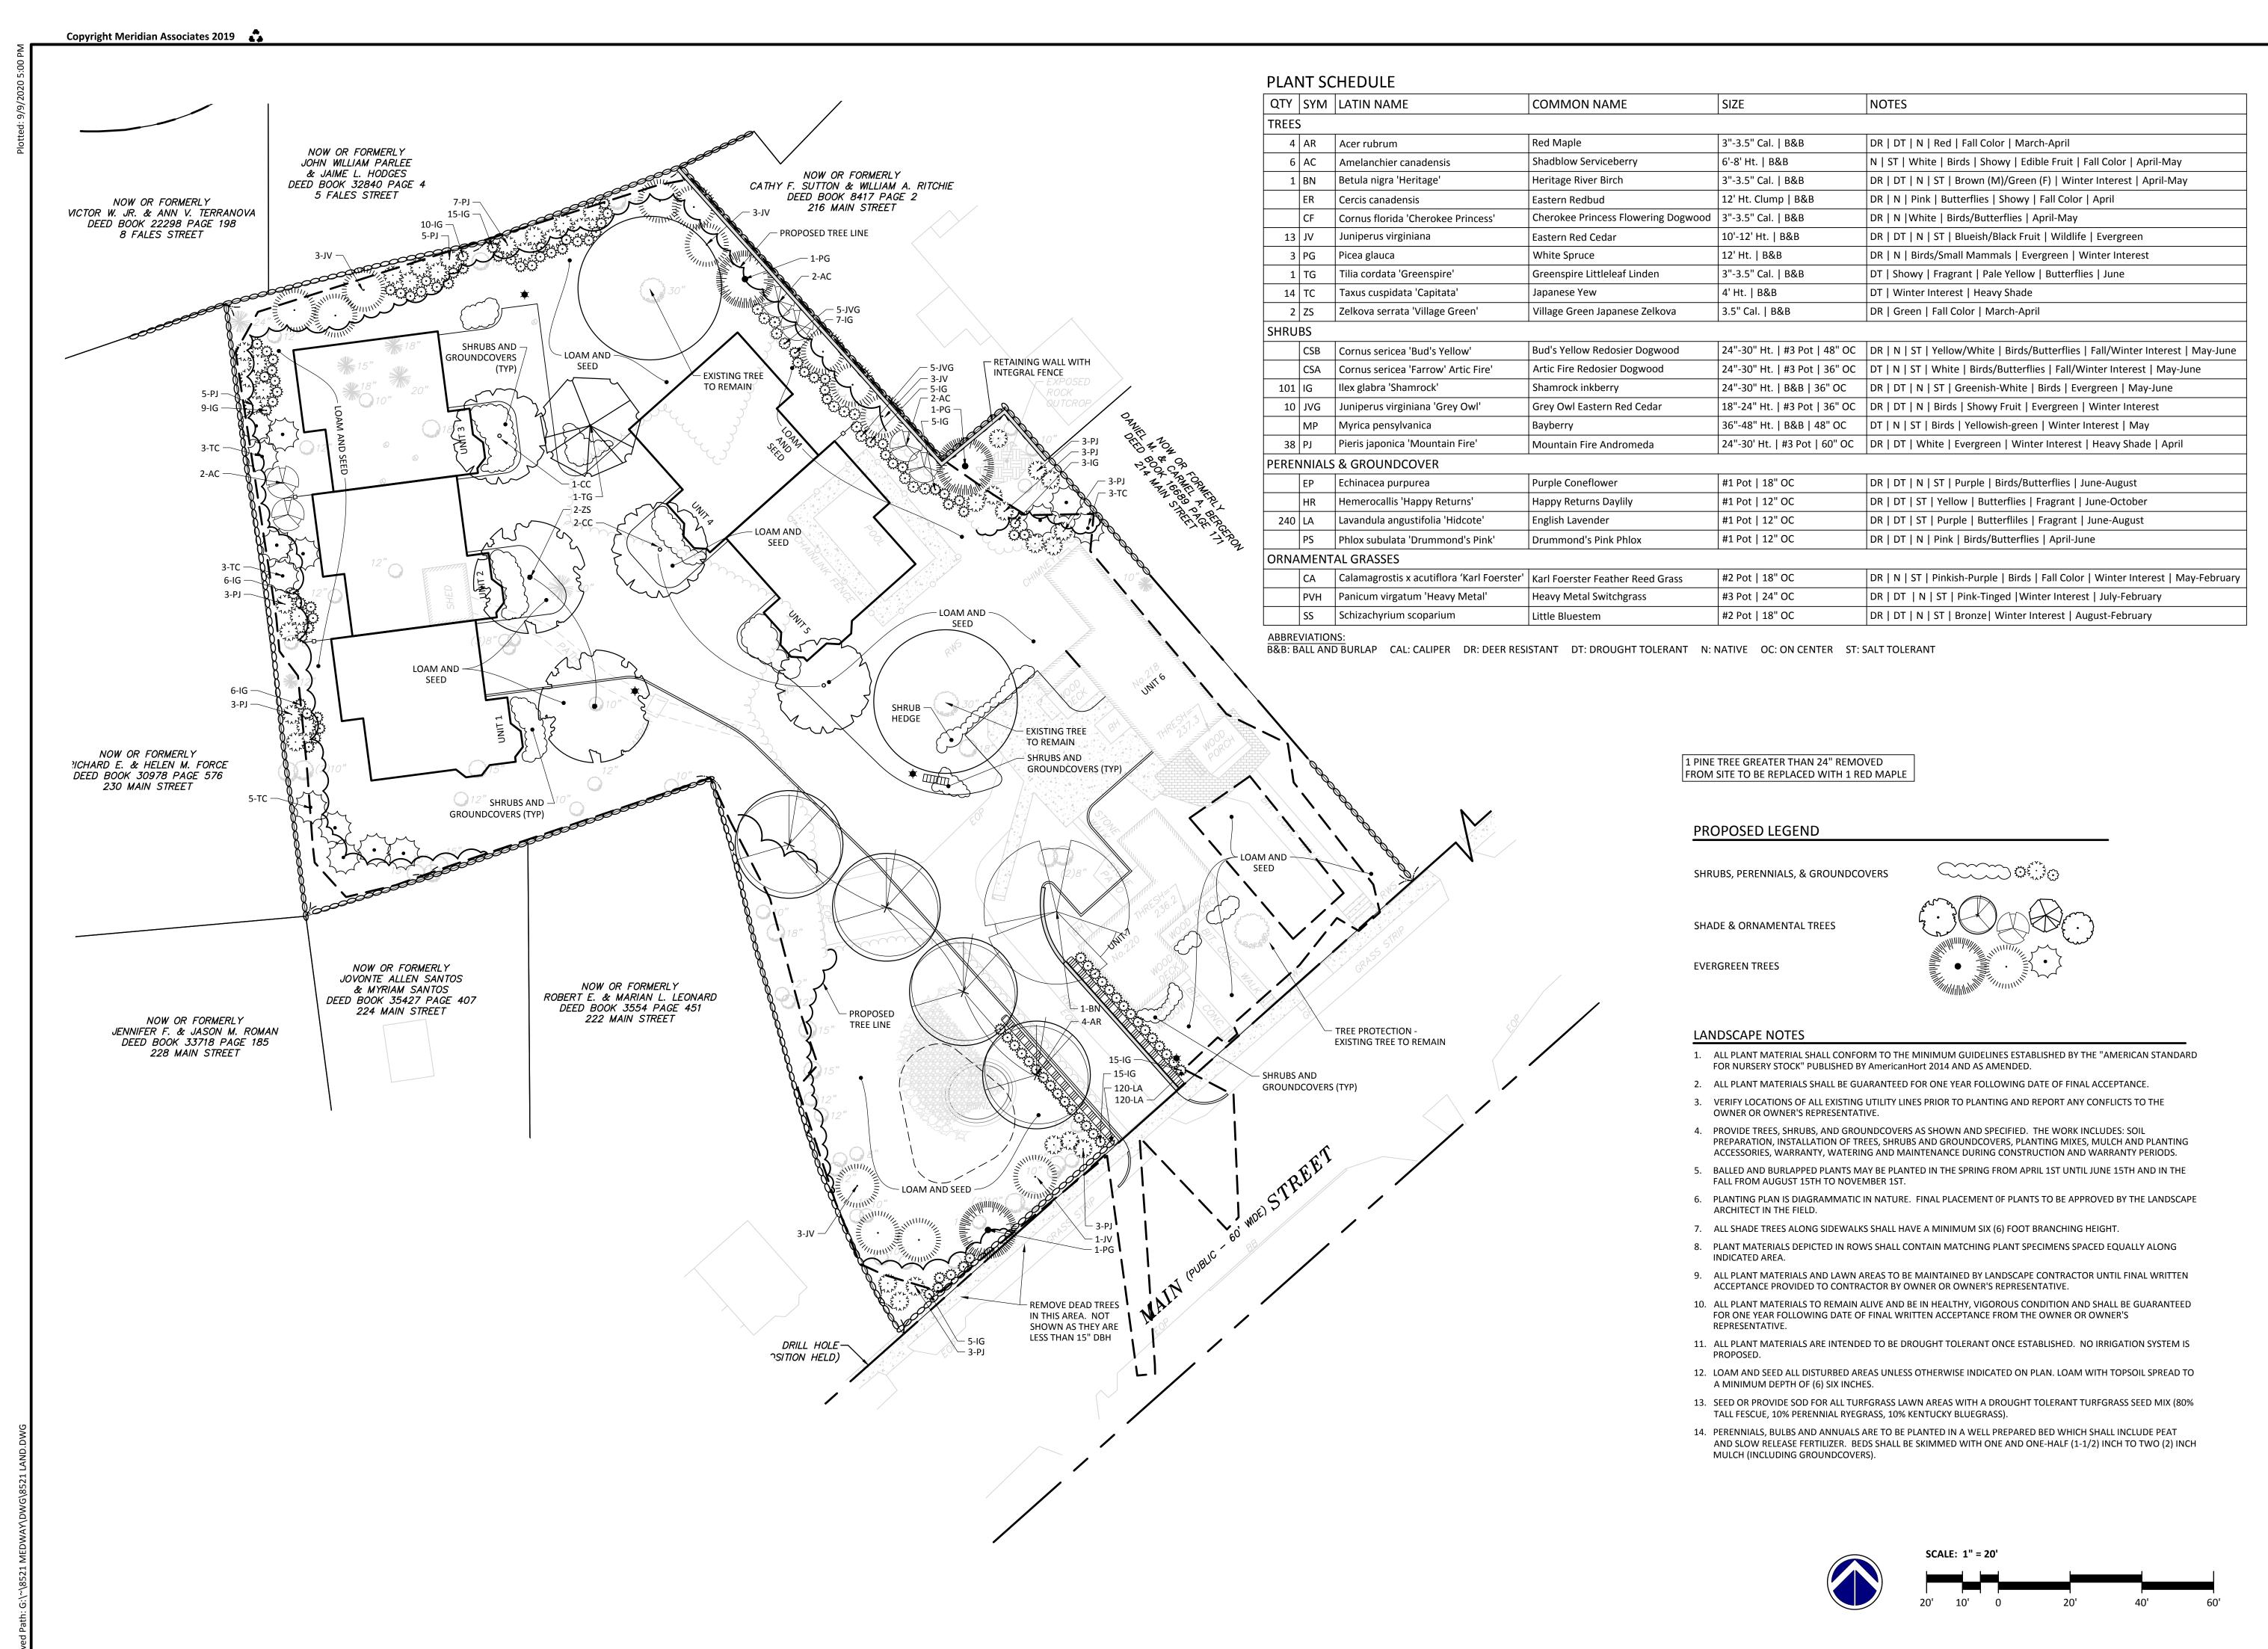



AN





Date: June 9, 2020


(See Revisions)


Scale:

1"=20'

Project No. 8521

Sheet No.

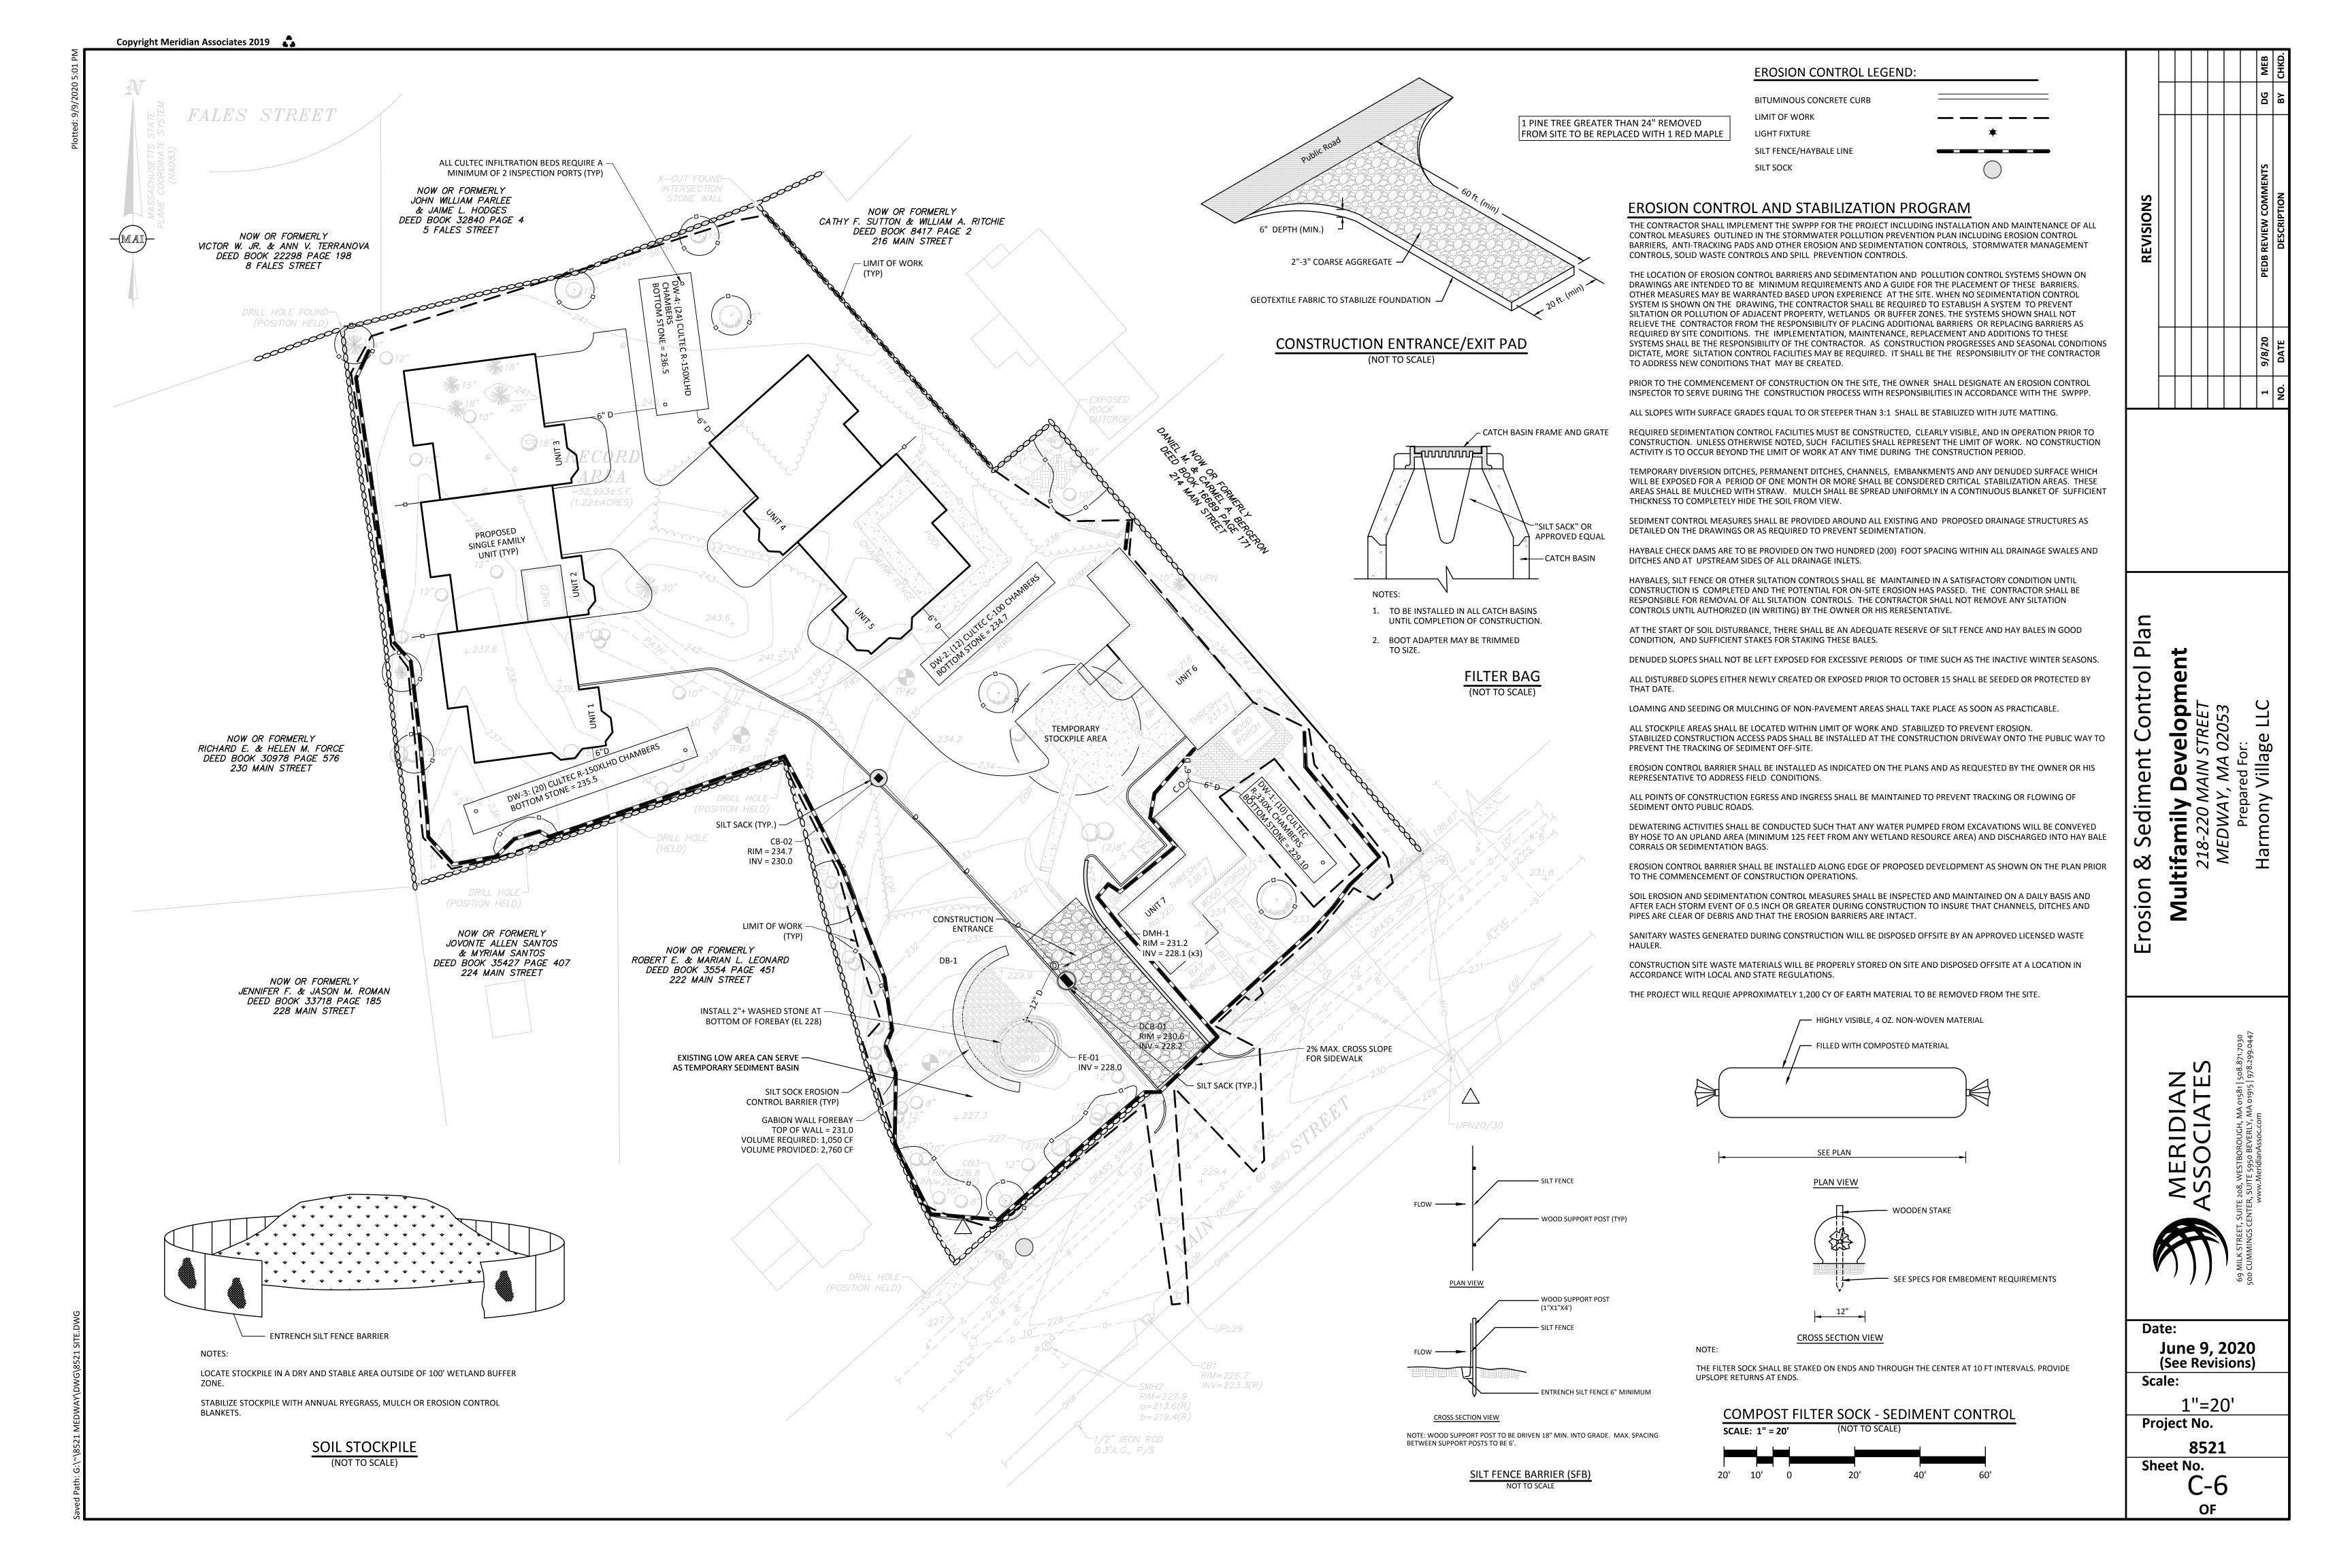

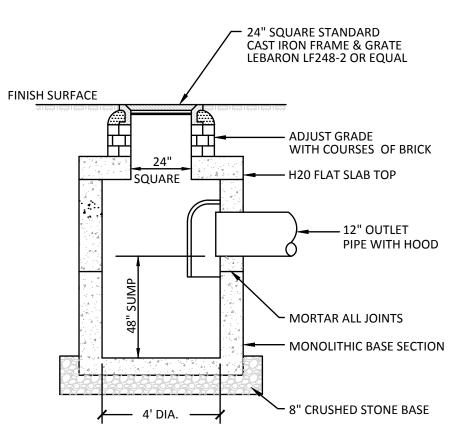


1. STRUCTURE DESIGN TO LATEST ASTM C478.

2. REINFORCING STEEL CONFORMS TO LATEST ASTM A 185 3. CONCRETE COMPRESSIVE STRENGTH - 4,000 PSI @ 28 DAYS.


4. FLAT SLAB TOP AASHTO H-20 5. ONE POUR MONOLITHIC

PRECAST CONCRETE CATCH BASIN W/ TRAP (NOT TO SCALE)

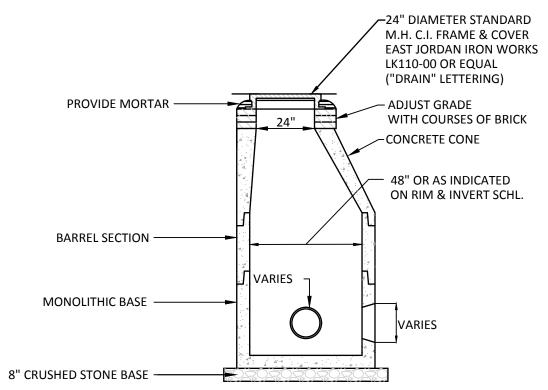


- 1. MANHOLE DESIGN TO LATEST ASTM C478.
- 2. REINFORCING STEEL CONFORMS TO LATEST ASTM A 185. 3. CONCRETE COMPRESSIVE STRENGTH - 4,000 PSI @ 28 DAYS.
- 4. ONE POUR MONOLITHIC BASE.
- 5. STEPS STEEL REINFORCED COPOLYMER POLYPROPYLENE PLASTICS (PS2-PFSL M.A. INDUSTRIES, INC.) CONFORMS TO LATEST ASTM C478 PARA-12.
- 6. BITUMASTIC BUTYL RUBBER FOR JOINTS CONFORM TO LATEST ASTM C443 AND FED SS-S-201A


PRECAST CONCRETE DRAIN MANHOLE (NOT TO SCALE)

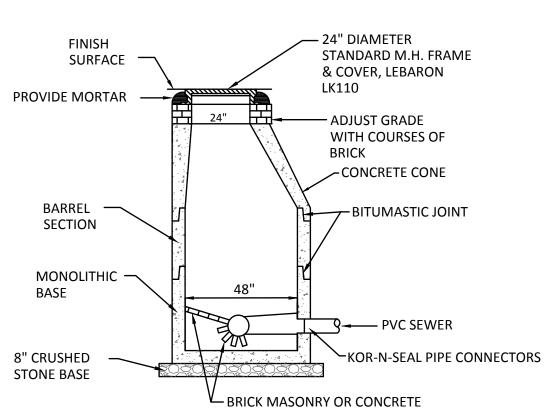

- MANHOLE DESIGN SHALL CONFORM TO LATEST ASTM C478.
- REINFORCING STEEL SHALL CONFORM TO LATEST ASTM A 185. 3. CONCRETE COMPRESSIVE STRENGTH-4,000 PSI @ 28 DAYS.
- 4. ONE POUR MONOLITHIC BASE.
- 5. STEPS-STEEL REINFORCED COPOLYMER POLYPROPELENE PLASTIC (PS2-PFSL M.A. INDUSTRIES,
- INC.) CONFORMING TO LATEST ASTM C478 PARA-12.
- 6. KOR-N-SEAL FLEXIBLE PIPE CONNECTORS SHALL CONFORM TO LATEST ASTM C923, A167.


SEWER MANHOLE DETAIL (SMH) (NOT TO SCALE)

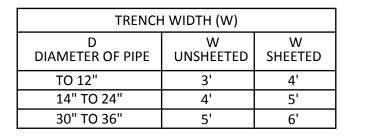


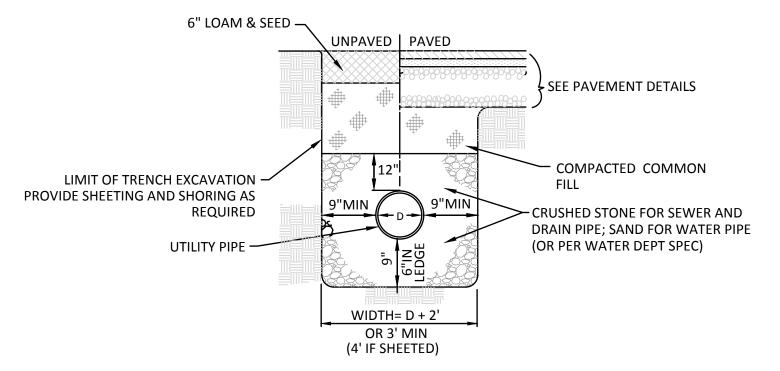


TYPICAL TRENCH SECTION


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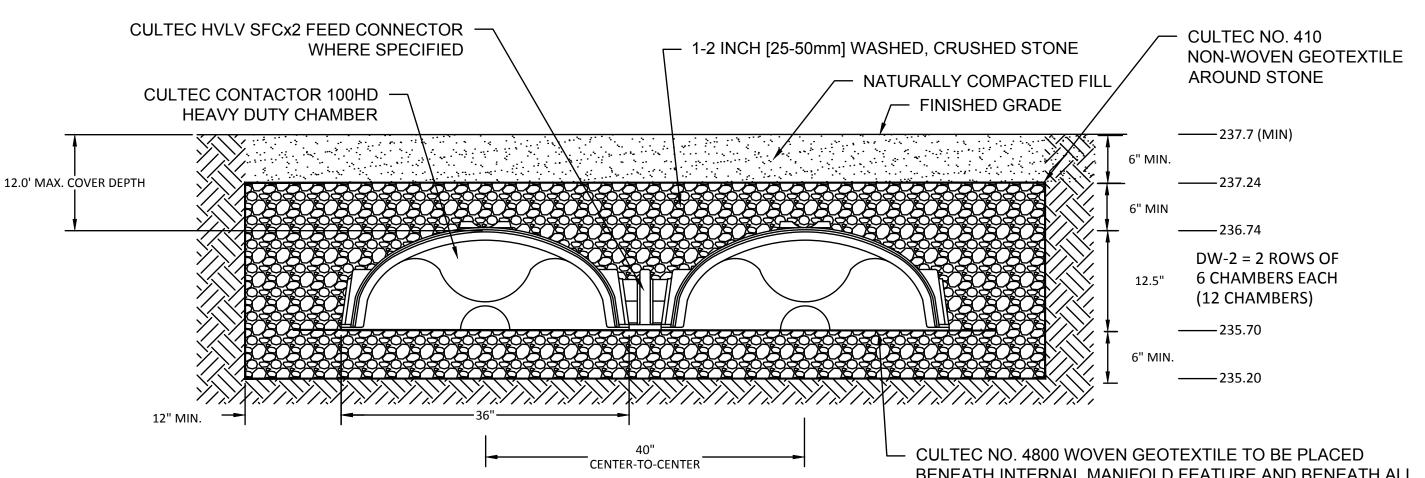


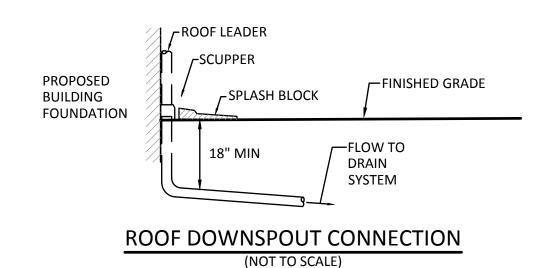

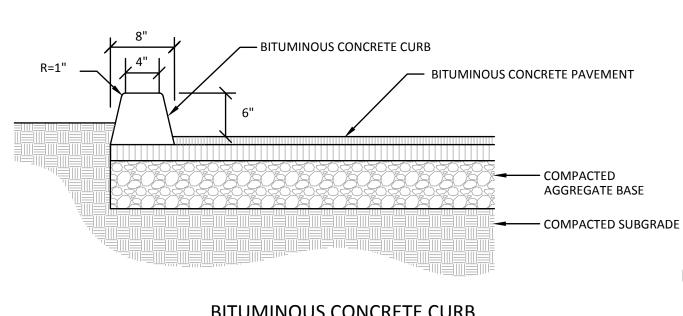


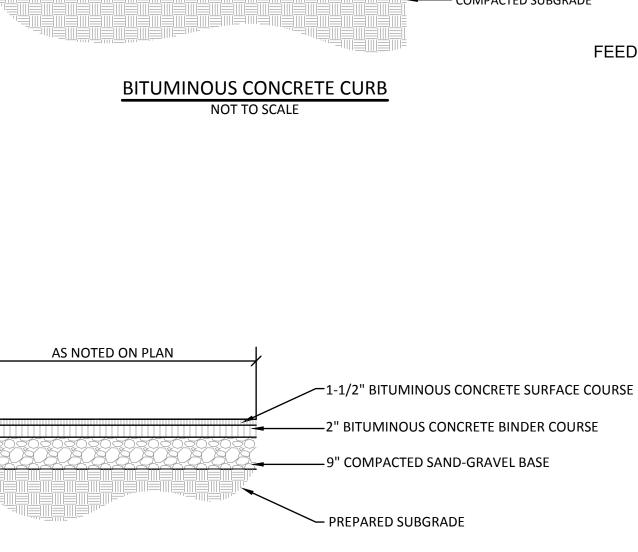BITUMINOUS CONCRETE PAVEMENT SECTION (NOT TO SCALE)



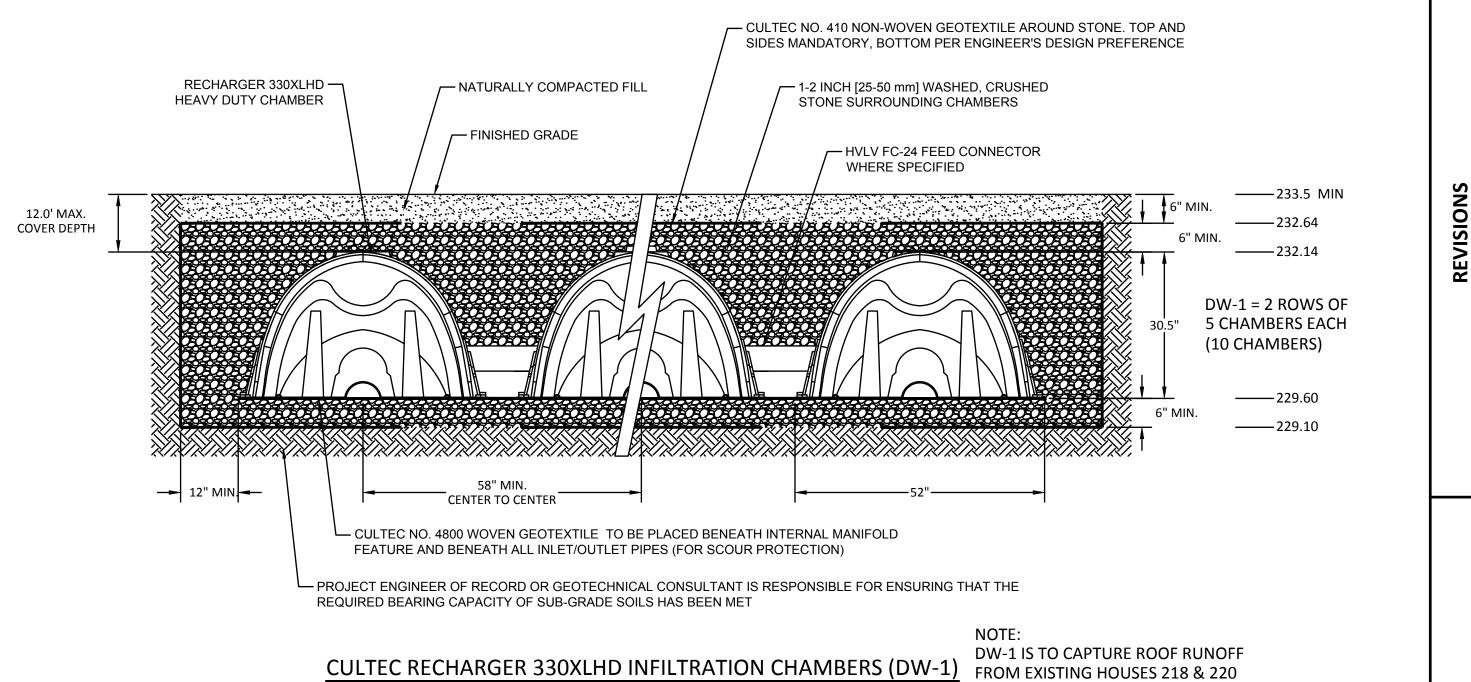


(NOT TO SCALE)

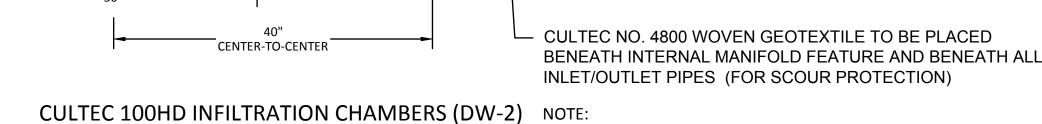

(UNITS 6 & 7).

BENEATH INTERNAL MANIFOLD FEATURE AND BENEATH

ALL INLET/OUTLET PIPES (FOR SCOUR PROTECTION)

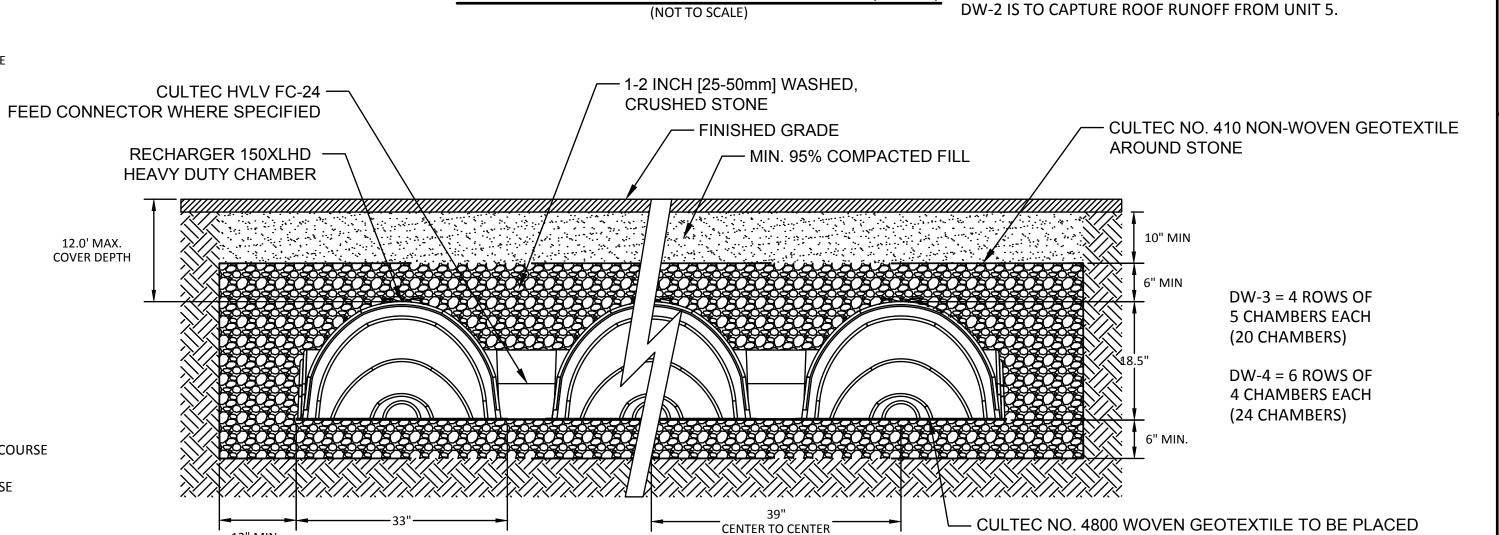

CULTEC 150XLHD INFILTRATION CHAMBERS (DW-3, DW-4) (NOT TO SCALE)

12" MIN.

DW-3 AND DW-4 ELEVATION SCHEDULE						
	I	BOTTOM OF CHAMBER	TOP OF CHAMBER		MIN. GROUND SURFACE	NOTE: DW-3 IS TO CAPTURE ROOF RUNOFF FROM UNITS 1 & 2. DW-4 IS TO CAPTURE ROOF RUNOFF FROM UNITS 3 & 4
DW-3	235.5	236.0	237.54	238.04	239.0	
DW-4	236.5	237.0	238.5	239.0	240.0	

evelopment IN STRRET 1A 02053 **Multifami** 218-220 MEDV SIT


Harm

MERIDIAN ASSOCIATES


Date: June 9, 2020 Scale:

N.T.S Project No. 8521


Sheet No. **L**-1 OF

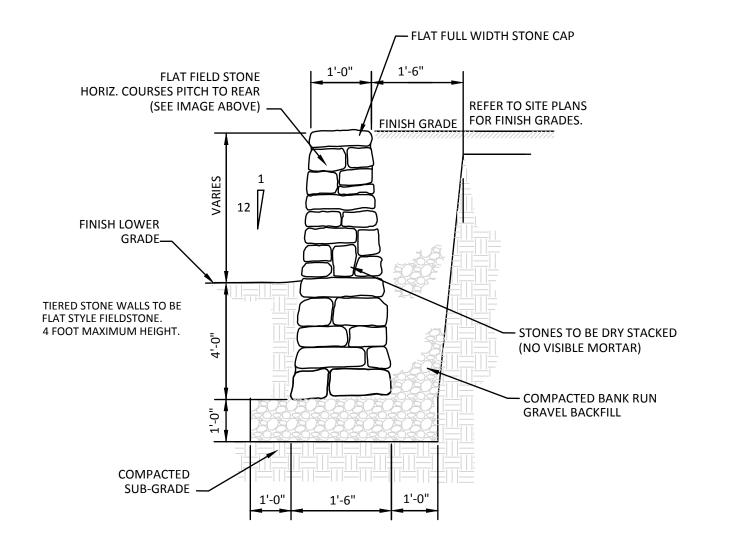


STONE RETAINING WALL

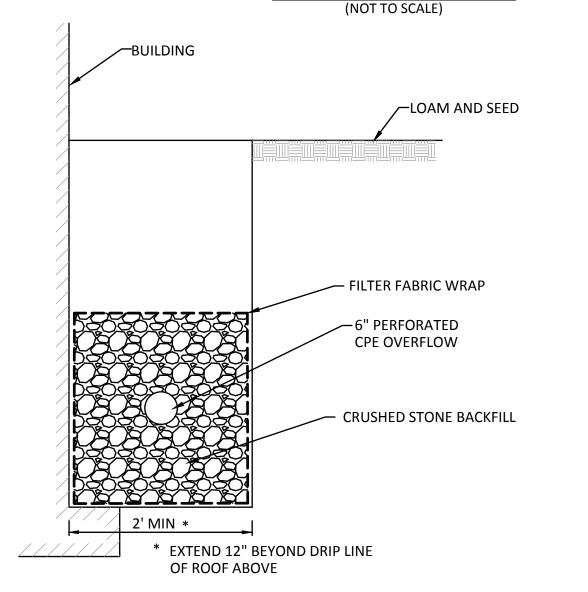


FOUNDATION DRAIN
(NOT TO SCALE)

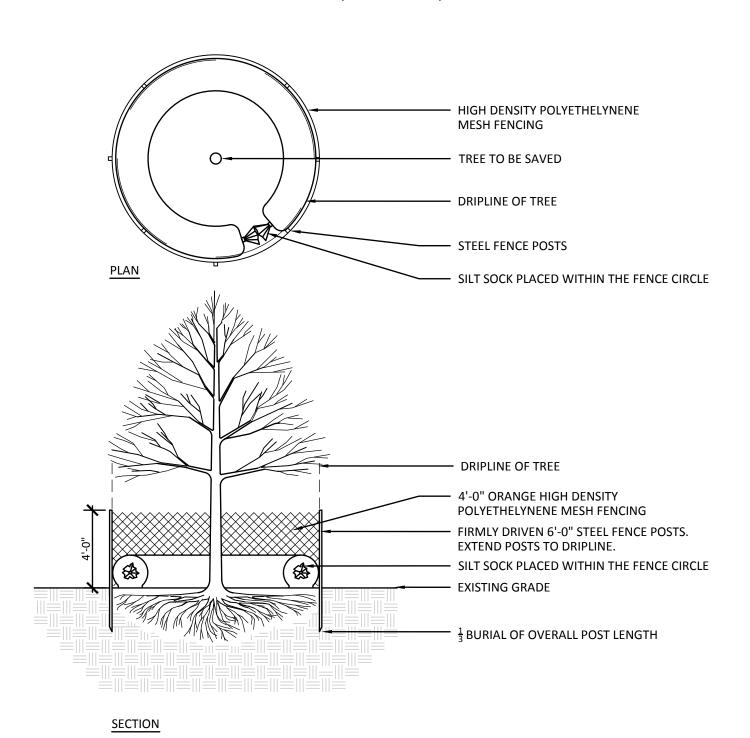


TREE PROTECTION

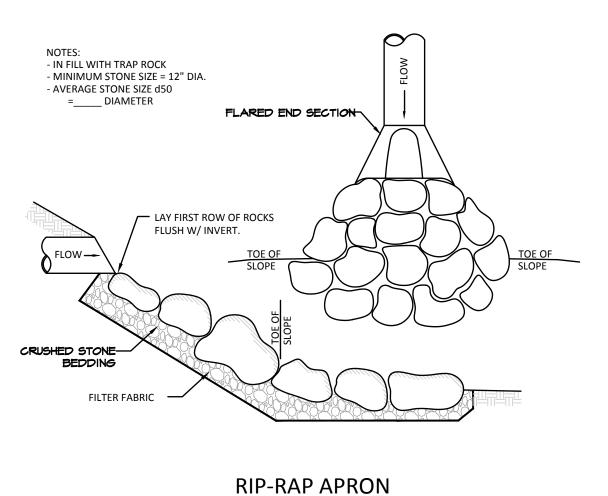

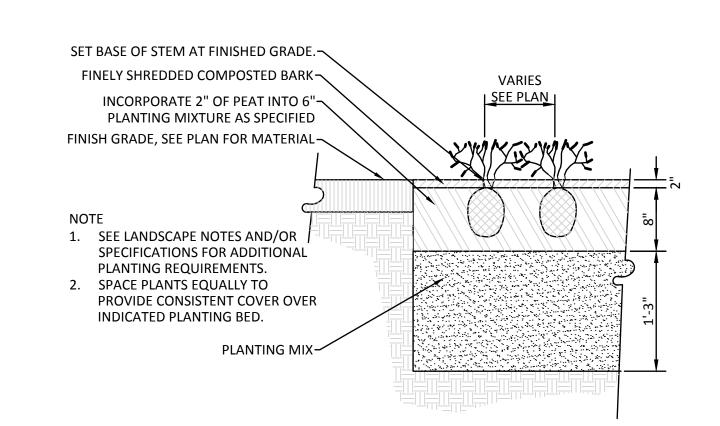

GROUNDCOVER / ANNUAL / PERENNIAL PLANTING
NOT TO SCALE

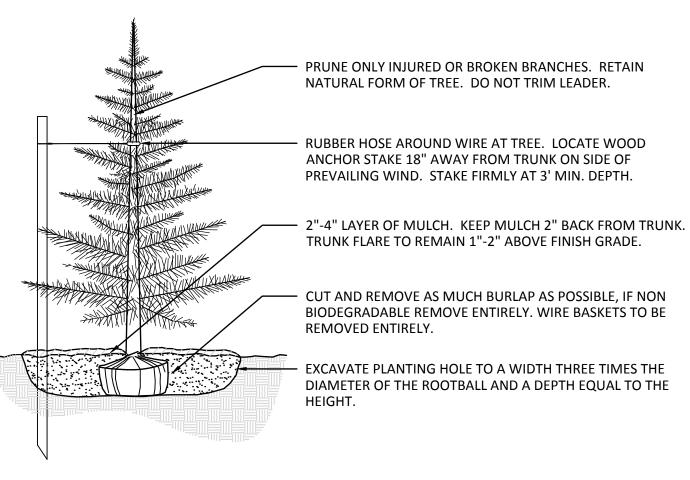

BACKFILL PLANTING HOLE WITH EXISTING SOIL AMENDED AS NECESSARY.


NOTES:


BACKFILL HALF THE SOIL AND WATER TO SETTLE OUT AIR POCKETS, COMPLETE BACKFILLING AND REPEAT WATERING.

IF ROOTS ARE CIRCLING THE ROOTBALL EXTERIOR, CUT ROOTS VERTICALLY IN SEVERAL PLACES PRIOR TO PLANTING.

ONLY STAKE TREES SITUATED ON WINDY SITES OR EXPOSED TO SUBSTANTIAL PEDESTRIAN TRAFFIC.

EVERGREEN TREE PLANTING
NOT TO SCALE

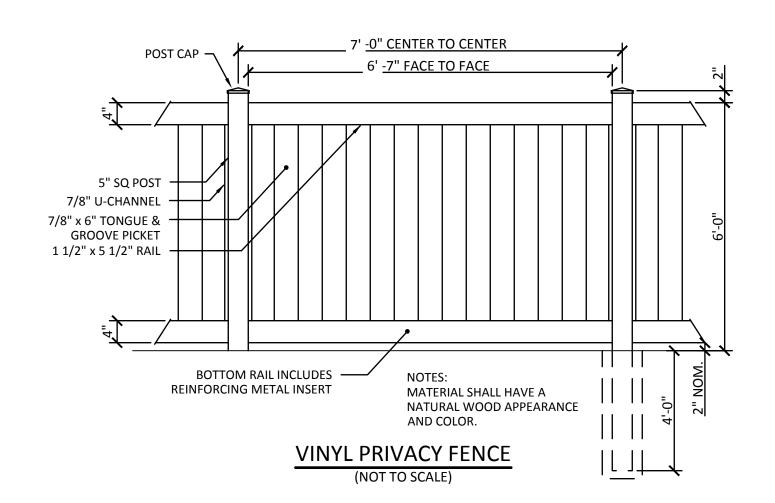

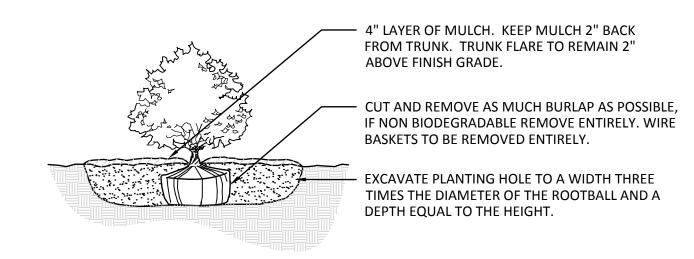


NOTES:

BACKFILL PLANTING HOLE WITH EXISTING SOIL AMENDED AS NECESSARY.

BACKFILL HALF THE SOIL AND WATER TO SETTLE OUT AIR POCKETS, COMPLETE BACKFILLING AND REPEAT WATERING.

IF ROOTS ARE CIRCLING THE ROOTBALL EXTERIOR, CUT ROOTS VERTICALLY IN SEVERAL PLACES PRIOR TO PLANTING.

SHRUB PLANTING

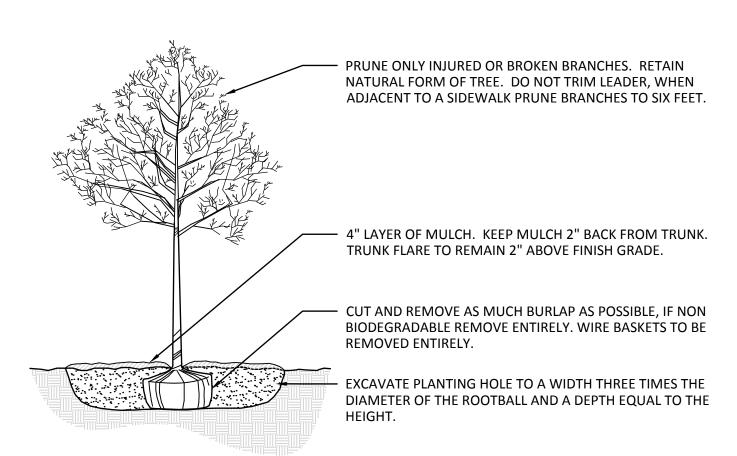

NOTES:

BACKFILL PLANTING HOLE WITH EXISTING SOIL AMENDED AS NECESSARY.

BACKFILL HALF THE SOIL AND WATER TO SETTLE OUT AIR POCKETS, COMPLETE BACKFILLING AND REPEAT WATERING.

IF ROOTS ARE CIRCLING THE ROOTBALL EXTERIOR, CUT ROOTS VERTICALLY IN SEVERAL PLACES PRIOR TO PLANTING.

ONLY STAKE TREES SITUATED ON WINDY SITES OR EXPOSED TO SUBSTANTIAL PEDESTRIAN TRAFFIC.

TREE PLANTING
NOT TO SCALE

SITE DETAILS

Multifamily Developmen
218-220 MAIN STRRET

MEDWAY, MA 02053

MERIDIAN
ASSOCIATES

SET, SUITE 208, WESTBOROUGH, MA 01581 | 508.871.7030

Date: June 9, 2020

N.T.S Project No. **8521**

Scale:

Sheet No.
C-8
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